

# Site Plan/Design Review Hunter Street Apartments

4 Unit Apartment Complex

748 Hunter Street APN: 139-056-001

# LEE . JAGOE ARCHITECTURE

F. Garcia

Stockton, California 95202

## 4-Unit **Apartments**

748 N Hunter St Stockton, CA 95202

### Team

Owner: Francisco Garcia 124 West Popular Street Stockton, CA 95202 (209) 688-0849

Architect: Lee-Jagoe Architecture, Inc. 2800 West March Lane, Suite 240 Stockton, CA 95219 (209) 957-9254

## Sheet Index

CS Cover Sheet/SIte Plan

SP1.0 Site Plan Surrounding Photos L1 Preliminary Landscape Plan A1.1 Unit Plan/Roof Plan

A2.0 Exterior Elevations A2.1 Exterior Elevations

A2.0 Colored Elevations

## Scope of Work

Construction of 4 Unit Apartment Project Project is to be completed in one phase See sheet SP1\_Site Plan for project data.

#### Land Area Data

APN: Zoning: 139-056-001 CO-Commercial Office Magnolia Historic District 5,000 sf 0.11 Acres 36.36 DU/AC Gross Area: Density:

Building Coverage: Driveway Coverage: Landscape Coverage: 2,176 sf 472 sf 2,352 sf 43.52% 09.44% 47.04%

Building Area: Floor Area Ratio: 3,884 Sf 0.78 to 1.00

All buildings two stories

Required Parking: Garage Parking: Open Parking:

.5 Spaces/Unit 2 Spaces Provided 2 Spaces Provided

Project

Location

Open Space:

2 Spaces Provided
Usable Open Space 104 Sf
236 Sf 110 Sf/Unit

Cover Sheet/ Site Plan with Ground Floor Plan

Scale: 3/16" = 1'-0"


	SUBMITTAL	06/03/25
Δ	PLAN CHECK #1	







P25-0018 EXHIBIT 1

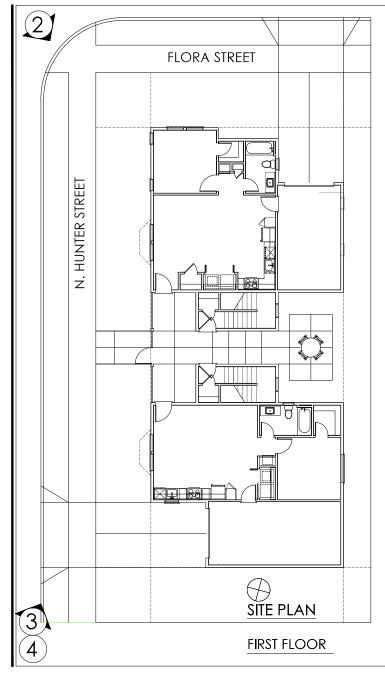





748 Hunter Street Southeast StreetView



2 748 Hunter Street South StreetView



748 Hunter Street Northeast StreetView



(4) 748 Hunter Street Northeast Aerial View



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Stockton, California 95202

4-Unit Apartments
748 N Hunter St
Stockton, CA 95202

Site Photos

Scale: 3/16" = 1'-0"

	SUBMITTAL	06/03/25			
Δ	PLAN CHECK #1				



SP1.0

This drawing is not final and shall not be used for construction work until it has been signed by the Landscape Architect

Sheet Number:

LI Of 3 Sheets

FLORA STREET 0 \*\* 

4. FINISH GRADE IN PLANTERS SHALL BE IN INCHES BELOW THE TOP OF ADJACENT PAVING. GRADE AUL PLANTING AREAS SMOOTH AND EVEN. ENSURE THAT ALL PLANTING AREAS MAINTAIN POSITIVE

PROPOSED	PLANT	LEGEND	TOTAL

Symbol TREES	Size	Botanical Name	Common Name	Water Use
_(``)	15 Gal.	Acer p. 'Bloodgood'	Red Japanese Maple	l
(	15 Gal.	Geijera parviflora	Australian Willow	L
<u> </u>	15 Gal.	Pistachia chinensis	Chinese Pistache	L
SHRUBS APO	5 Gal. 5 Gal. 5 Gal.	Bacchana p. Pigeon Point' Ceanothus g.h. Yaskee Point' Loropetalum chineneie	Dwarf Coyote Brush Yankee Point Calfornia Lila Chinese Fringe Flower	e L
00	5 Gal. 5 Gal.	Pittosporum Wheelers Dwarf Phormium t. 'rubra'	Dwarf Pittosporum Red New Zealand Flax	Ĺ

**1** 5 Gal.

Dietes vegeta Fortnight Lily Linope in Silvery Sunproof Vanegated Lily Turf Seed Myoporum p. 'Prostratum' - White Creeping Myoporum

### MWELO CALCULATIONS

MAWA = (EFo) (0.62) (0.45 X LA)+(1-0.45 X SLA) = (49.1)(0.62)(0.45 X 2.640.8) = (49.1)(0.62)(1.188.4) = 36,177.3 GALLONS PER YEAR

HYDROZONE PLANT FACTOR IRRIGATION EFFICIENCY ETAF HYDROZONE AREA (HA)
- 0.4 0.81 0.32 2.640.8

= (ETo)(O.G2)(ETAF)(HA)

= (49.1) (0.62)(0.32)(2.640.8))

= 25,725,2 GALLONS PER YEAR

MAWA:36,177.3 > ETWU: 25,725.2

#### LANDSCAPE SUMMARY

(A)

HUNTER STREET

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PLANTING NOTES


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A BID.

THE AMBIGNATE CONTRACTOR IS TO NOTIFY THE DWARROWNESS REPRESENTATIVE 46 HOURS PRIOR TO A REQUIRED SITE OF SERVICE OF THE AMBIGNATION OF THE THE AMBIGNATION OF THE THE CONTRACTOR OF THE AMBIGNATION OF THE AMBIGNATIO

\* I HAVE COMPLIED WITH THE CRITERIA OF THE MODEL WATER EFFICIENT LANDSCAPE ORDINANCE AND APPLIED THEM FOR THE EFFICIENT USE OF WATER IN THE LANDSCAPE AND IRRIGATION DESIGN PLANS

P25-0018 EXHIBIT 1

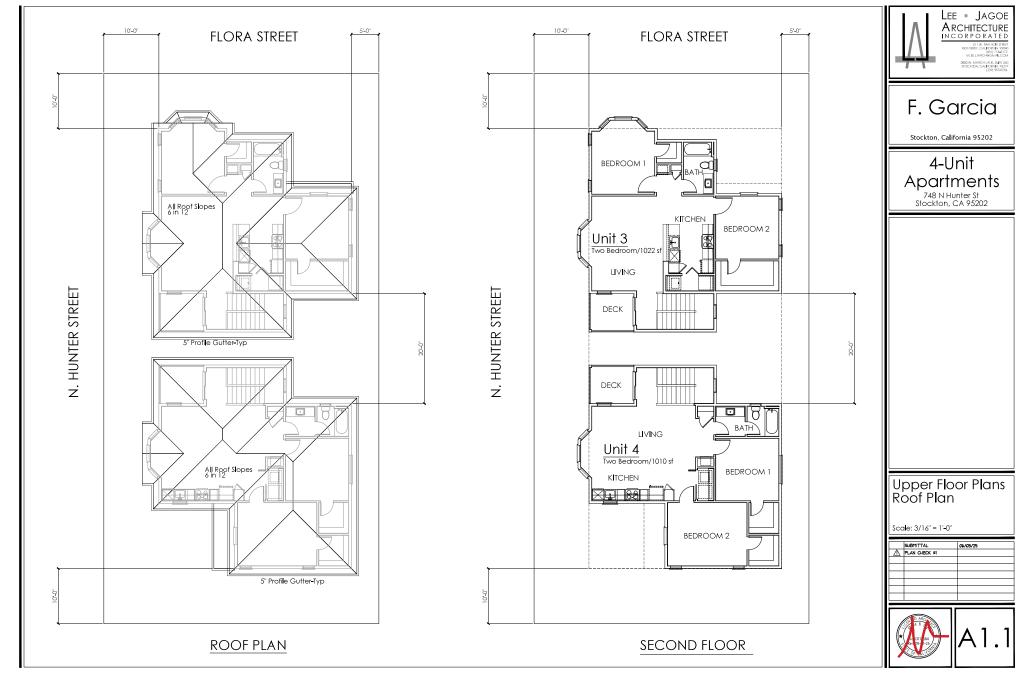

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