LEGEND

———— PROPERTY LINE

PROPOSED CURB &

EX 6' HIGH WOOD

FENCE

NEW 6'-8" HIGH CMU

PAVING

PROPOSED

BLOCK WALL

PROPOSED 6" HIGH

CONCRETE SIDEWALK

PROPOSED CONCRETE

LANDSCAPED AREAS

CONCRETE CURB

CHAIN-LINK FENCE

EX 6' HIGH CMU **BLOCK WALL**

—— – CENTERLINE

===== EX CURB &

---- GUTTER

Design Group 1915 Carolina Ave. Clovis CA 93611

PH: 559. 593.9692

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≺∕Janice K. Bier∖ C22169 Renewal Date: ,) 02/28/27 **/**

 $\overline{\mathbf{C}}$

Date: 10.13.25 Drawn By: Susan Jones Project # 24029

Site Plan

Revisions

SHEET No.

Vicinity Map

PHASE 2

PHASE 3

8,784sf

PROJECT DATA

GROVE DEVELOPMENT CO. 7502 N. COLONIAL AVE. STE 101

FRESNO, CA 93711 PH: 559-355-3000

STOCKTON CA

MORADA & WEST LANE

090-550-640 & 650

EXISTING ZONING: CN (COMMERCIAL NEIGHBORHOOD)
EXISTING USE: VACANT

Building Areas / Site Areas

PARCEL 1: 2,483sf / 0.883 AC / 38,495sf PARCEL 2: 3,758sf / 1.115 AC / 48,579 sf PARCEL 3: 8,784sf / 0.694 AC / 30,244 sf

Const Type/ Occupancy

BUILDINGS A - COFFEE SHOP / PARCEL 1 B OCCUPANCY

BUILDINGS B - RESTAURANT / PARCEL 2

BUILDING 'C' - OFFICE/RETAIL - PARCEL 3
B OCCUPANCY

Parking Requirements

OFFICE / BUSINESS AT 1 STALL PER EMPLOYEE RETAIL AT 1 STALL PER 200sf OF FLOOR AREA

BLDG A = 2,203 / 100 = 22 STALLS

PARCEL B (FAST FOOD)
BLDG B = 3,758sf / 100 = 38 STALLS

PARCEL C (RETAIL/OFFICE)
BLDG C = 8,784sf / 250 = 35 STALLS

PER CBC 2022 TABLE 11B-208.2 ACCESSIBLE STALLS

Parking Provided

PARKING PROVIDED PARCEL A

ACCESSIBLE STALLS OPEN

TABLE 504.3: ALLOWABLE HEIGHT: 60 FEET

TABLE 504.4: ALLOWABLE STORY: 3 -STORY

PARKING REQUIRED
FAST FOOD RESTAURANT AT 1 SPACE PER 100SF FLOOR AREA
COFFEE AT 1 SPACE PER 150SF FLOOR AREA

TABLE 504.3: BASIC ALLOWABLE HEIGHT: 40 FEET
TABLE 504.4: BASIC ALLOWABLE STORY: 1-STORY
TABLE 506.2: BASIC ALLOWABLE AREA FACTOR: 9,000 SQ. FT.

TABLE 504.3: BASIC ALLOWABLE HEIGHT: 40 FEET
TABLE 504.4: BASIC ALLOWABLE STORY: 1-STORY
TABLE 506.2: BASIC ALLOWABLE AREA FACTOR: 6,000 SQ. FT.

TABLE 506.2: ALLOWABLE AREA : 36,000 SQ. FT. (S1)

= 95 STALLS

TIER 1 TABLE 5.106.5.3.1 TOTAL PARKING PROVIDED (26-50)

TIER 1 TABLE 5.106.5.3.1 TOTAL PARKING PROVIDED (26-50)

TIER 1 TABLE 5.106.5.3.1 TOTAL PARKING PROVIDED (26-50)

NO. STALLS

QTY.

QTY.

33

NO. STALLS

NO. STALLS

PROPOSED USE: CG (COMMERCIAL GENERAL)

GENERAL LAND USE: COMMERCIAL

PARCEL SIZE: ±2.69 AC

CONST.

CONST. SPRINKLERS

SPRINKLERS

A2 OCCUPANCY

SPRINKLED BLDG A

PARCEL A (COFFEE)

TOTAL REQUIRED

PARKING TYPE

STANDARD STALLS

COMPACT STALLS

TOTAL PARKING

EV CAPABLE

PARKING TYPE

STANDARD STALLS

CALGREEN EV STALLS

TYPES OF EV STALLS

EVCS (THE REQ'D NO. COUNTS TOWARD TOTAL REQ'D EV STALLS)

PARKING PROVIDED PARCEL C

ACCESSIBLE STALLS OPEN

TOTAL PARKING

EV CAPABLE

PARKING TYPE

STANDARD STALLS

COMPACT STALLS TOTAL PARKING

EV CAPABLE

CALGREEN EV STALLS

TYPES OF EV STALLS

EVCS (THE REQ'D NO. COUNTS TOWARD TOTAL REQ'D EV STALLS)

CALGREEN EV STALLS

TYPES OF EV STALLS

EVCS (THE REQ'D NO. COUNTS TOWARD TOTAL REQ'D EV STALLS)

PARKING PROVIDED PARCEL B

ACCESSIBLE STALLS OPEN

APPLICANT:

A.P.N.:

ane Morada enter ∞ nmerci



Date: 10.13.25 Drawn By: Susan Jones Project # 24029

Phase Plan

Revisions

SHEET No.

SITE SUTHERLAND DR LEGEND PHASE ONE W. WESTMORA AVE. PHASE TWO PHASE THREE Vicinity Map

SINGLE FAMILY RESIDENCE PHASE PLAN

+PARCEL 2

BUILDING B

NOT PART

OF SCOPE OF WORK

PHASE

On st A roposed IEC of W tockton

PROJECT DATA

GROVE DEVELOPMENT CO. 7502 N. COLONIAL AVE. STE 101

FRESNO, CA 93711 PH: 559-355-3000

STOCKTON CA

MORADA & WEST LANE

090-550-640 & 650

THRU & PROPOSED PARCEL 3 WITH GENERAL RETAIL & OFFICE

TABLE 504.3: BASIC ALLOWABLE HEIGHT: 40 FEET
TABLE 504.4: BASIC ALLOWABLE STORY: 1-STORY
TABLE 506.2: BASIC ALLOWABLE AREA FACTOR: 9,000 SQ. FT.

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TABLE 506.2: ALLOWABLE AREA : 36,000 SQ. FT. (S1)

= 35 STALLS = 95 STALLS

PER CBC 2022 TABLE 11B-208.2 ACCESSIBLE STALLS

TIER 1 TABLE 5.106.5.3.1 TOTAL PARKING PROVIDED (26-50)

TIER 1 TABLE 5.106.5.3.1 TOTAL PARKING PROVIDED (26-50)

TIER 1 TABLE 5.106.5.3.1 TOTAL PARKING PROVIDED (26-50)

NO. STALLS

33

NO. STALLS

35

NO. STALLS

35

EXISTING ZONING: CN (COMMERCIAL NEIGHBORHOOD)
EXISTING USE: VACANT

Building Areas / Site Areas

PARCEL 1: 2,483sf / 0.883 AC / 38,495sf PARCEL 2: 3,758sf / 1.115 AC / 48,579 sf PARCEL 3: 8,784sf / 0.694 AC / 30,244 sf

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BUILDINGS A - COFFEE SHOP / PARCEL 1 B OCCUPANCY

BUILDINGS B - RESTAURANT / PARCEL 2

BUILDING 'C' - OFFICE/RETAIL - PARCEL 3
B OCCUPANCY

Parking Requirements

COFFEE AT 1 SPACE PER 150SF FLOOR AREA OFFICE / BUSINESS AT 1 STALL PER EMPLOYEE RETAIL ÁT 1 STALL PER 200sf OF FLOOR AREA

BLDG A = 2,203 / 100 = 22 STALLS

PARCEL B (FAST FOOD)
BLDG B = 3,758sf / 100 = 38 STALLS

TABLE 504.3: ALLOWABLE HEIGHT: 60 FEET

TABLE 504.4: ALLOWABLE STORY: 3 -STORY

PARKING REQUIRED
FAST FOOD RESTAURANT AT 1 SPACE PER 100SF FLOOR AREA

PROPOSED USE: CG (COMMERCIAL GENERAL)

GENERAL LAND USE: COMMERCIAL

PARCEL SIZE: ±2.69 AC

CONST.

CONST. SPRINKLERS

SPRINKLERS

A2 OCCUPANCY

SPRINKLED BLDG A

PARCEL A (COFFEE)

TOTAL REQUIRED

PARKING TYPE

STANDARD STALLS

COMPACT STALLS

CALGREEN EV STALLS

TYPES OF EV STALLS

EVCS (THE REQ'D NO. COUNTS TOWARD TOTAL REQ'D EV STALLS)

PARKING PROVIDED PARCEL B

ACCESSIBLE STALLS OPEN

TOTAL PARKING

EV CAPABLE

PARKING TYPE

STANDARD STALLS

CALGREEN EV STALLS

TYPES OF EV STALLS

EVCS (THE REQ'D NO. COUNTS TOWARD TOTAL REQ'D EV STALLS)

PARKING PROVIDED PARCEL C

ACCESSIBLE STALLS OPEN

TOTAL PARKING

EV CAPABLE

PARKING TYPE

STANDARD STALLS

CALGREEN EV STALLS

TYPES OF EV STALLS

EVCS (THE REQ'D NO. COUNTS TOWARD TOTAL REQ'D EV STALLS)

COMPACT STALLS TOTAL PARKING

EV CAPABLE

NORTH

1"=30'-0"

PARCEL C (RETAIL/OFFICE) BLDG C = 8,784sf / 250

Parking Provided


PARKING PROVIDED PARCEL A

ACCESSIBLE STALLS OPEN

APPLICANT:

A.P.N.:

ane Morada enter nmercial ∞ OIT st A Proposed NEC of W Stockton,

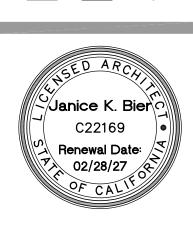


Date: 10.13.25 Drawn By: Susan Jones Project # 24029

Exhibit Site Plan

SHEET No.

A1.0b

Revisions

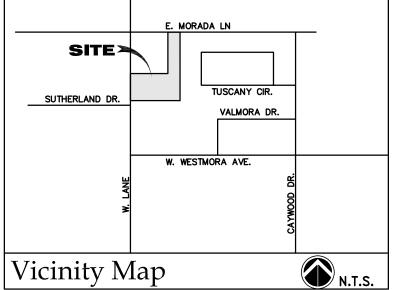

1915 Carolina Ave. Clovis CA 93611


PH: 559. 593.9692

Floor Plan Bldg A

Revisions

SHEET No.

\2.1

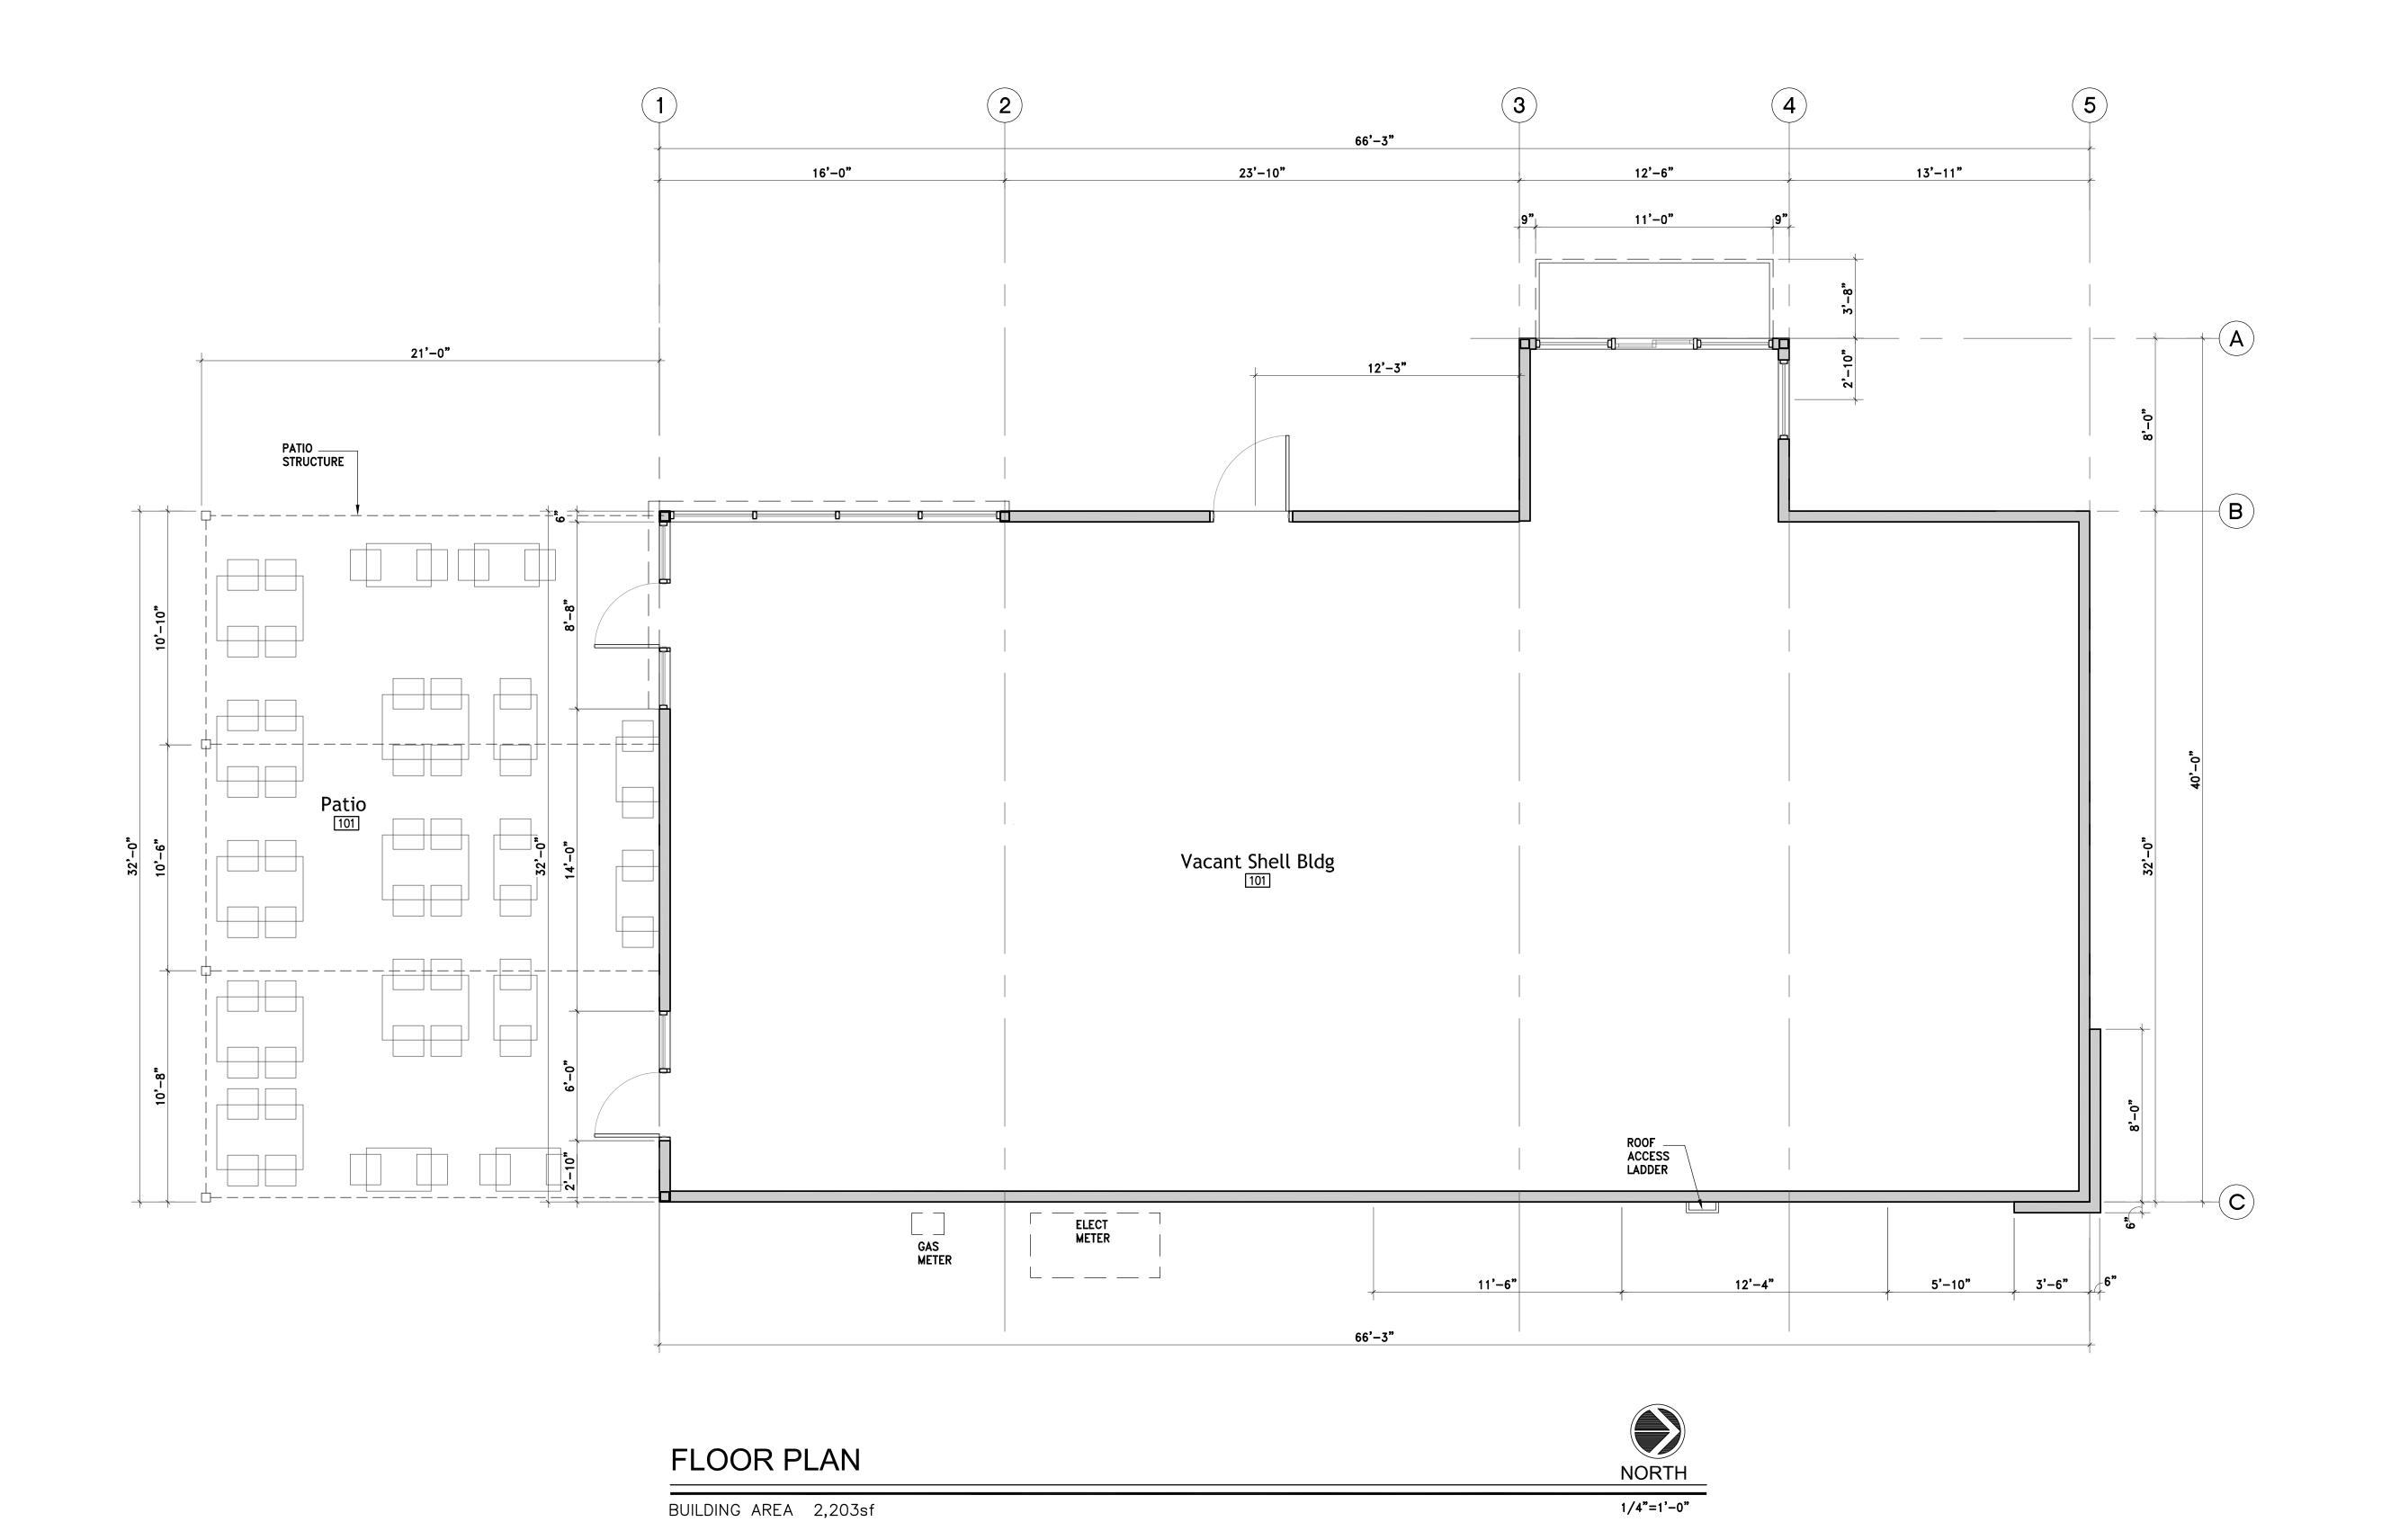

REQUIRED PRIOR TO INSTALLATION

2. PRE-MANUFACTURED METAL CANOPIES ARE DEFERRED ITEMS AND SHALL BE SUBMITTED TO ARCHITECT & EOR & LOCAL BUILDING DEPARTMENT FOR REVIEW AND APPROVAL PRIOR TO PURCHASE AND INSTALLATION.

EXHIBIT 2

PH: 559. 593.9692

ane

Morada

∞

les CA

enter

mmercial

 $\frac{0}{2}$

No. Description

- JAMES HARDIE PLANK SMOOTH FINISH
- 1 | PAINTED "TIMBER BARK"
- 7/8" CEMENT PLASTER (PAINTED) o/ METAL LATH o/ TYVECK WATER RESISTIVE MEMBRANE o/ SHEATHING PAINTED SHERWIN WILLIAMS SW 7004 "SNOWBOUND"
- ALUMINUM STOREFRONT DOOR & WINDOW 3 SYSTEM 4 ½" COLOR "DARK BRONZE"
- BRONZE"

 HOLLOW METAL DOOR PAINTED SHERWIN
 WILLIAMS SW 7066 "GRAY MATTERS"
- 6 PRE-FINISHED METAL COPING PAINTED SHERWIN WILLIAMS SW 7069 "IRON ORE"
- 7 | STUCCO CONTROL JOINT
- 8 EXTERIOR SCONE LIGHT
- 9 PRE-MANUFACTURES METAL CANOPY WITH OPEN BOTTOM AND ROOF PANEL. COLOR
- "GRAY MATTERS"
- DASHED LINES INDICATE ROOF MOUNTED EQUIPMENT SCREENED BY PARAPET
- DASHED LINE INDICATES ROOF LINE FOR REFERENCE ONLY
- BUILDING ADDRESS SIGN SHALL BE A MIN. OF 6"
 IN HEIGHT AND SHALL BE OF A COLOR TO
- 14 | SIGNAGE SHOWN FOR REFERENCE ONLY, SEPARATE APPLICATION AND APPROVAL
- 15 EXTERIOR WALL LIGHT
- 16 12" DEEP BREAK METAL TO MATCH STOREFRONT
- 17 NOT USED
- ELECTRICAL METER CENTER PAINTED SHERWIN
- 6" DIAMETER STEEL PIPE CONC. FILLED BOLLARD PAINTED SAFETY YELLOW 48" HIGH
- 20 DRIVE THRU MENU 3-PANEL MENU BOARD
- DRIVE THRU CANOPY AND SPEAKER/ORDER POST
- 22 | PATIO METAL CANOPY W/ SOLAR PANELS
- 24 ROOF ACCESS LADDER
 - 7/8" CEMENT PLASTER (PAINTED) o/ METAL LATH o/ TYVECK WATER RESISTIVE MEMBRANE o/ SHEATHING PAINTED SHERWIN WILLIAMS SW 7069 "IRON ORE"

- 4 DRIVE-THRU WINDOW w/ SHELF IN "DARK
- WILLIAMS SW 7066 "GRAY MATTERS"
- | MATCH TO SHERWIN WILLIAMS "IRON ORE" MECHANICAL ROOF SCREEN HORIZONTAL
- RIBBED METAL PANEL BY ROOF SCREEN OR EQ. PAINTED SHERWIN WILLIAMS SW 7066

- CONTRAST WITH THEIR BACKGROUND
- REQUIRED
- FRAME
- WILLIAMS SW 7004 "SNOWBOUND"

- ABOVE

 3 FOOT HIGH WROUGHT IRON PATIO FENCING POWDER COATED COLOR TO MATCH SHERWIN WILLIAMS SW 7069 "IRON ORE"




Date: 10.13.25 Drawn By: Susan Jones Project # 24029


Exterior Elevations

Revisions

SHEET No.

A3.1

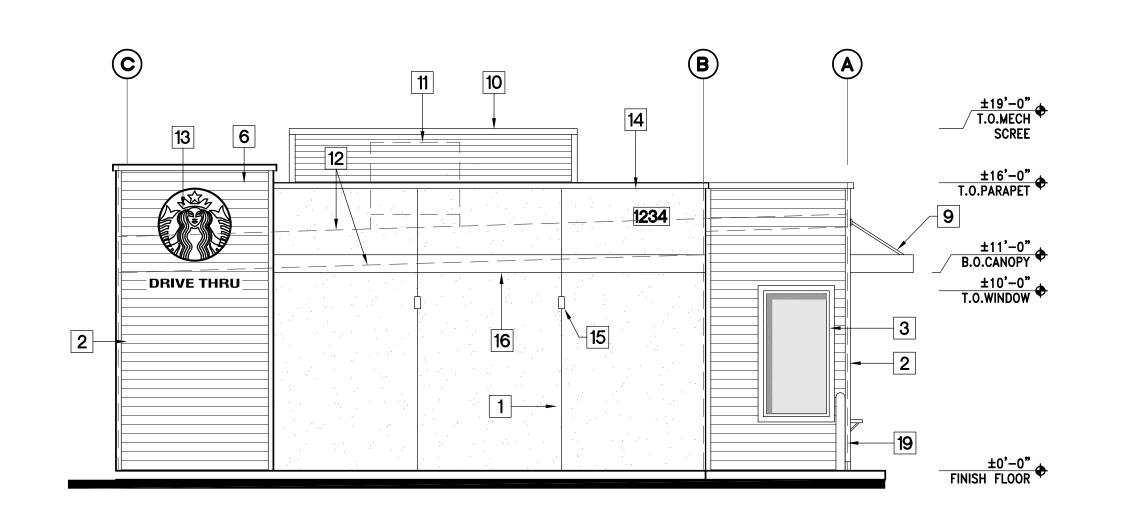

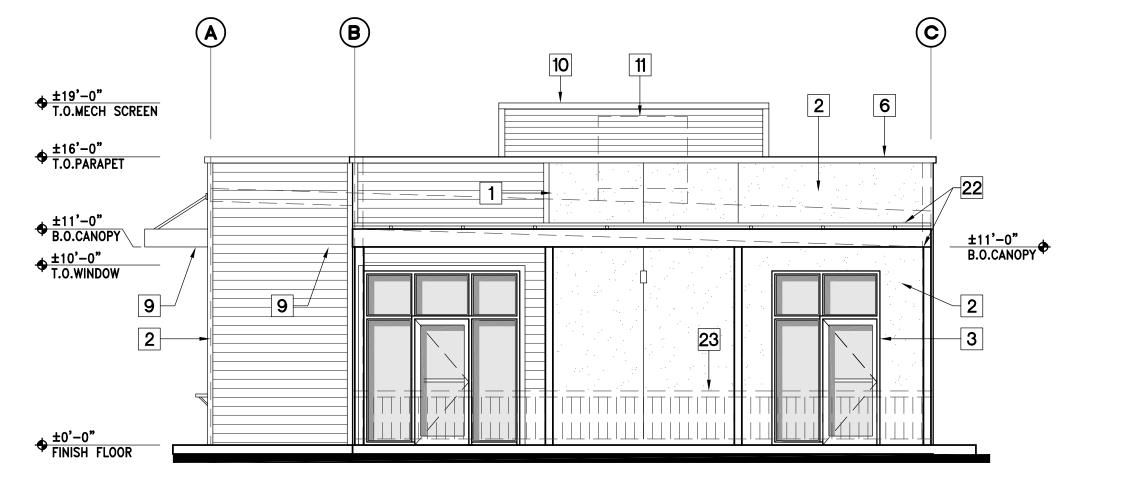


NORTH ELEVATION

3/16"=1'-0"


SOUTH ELEVATION

3/16"=1'-0"

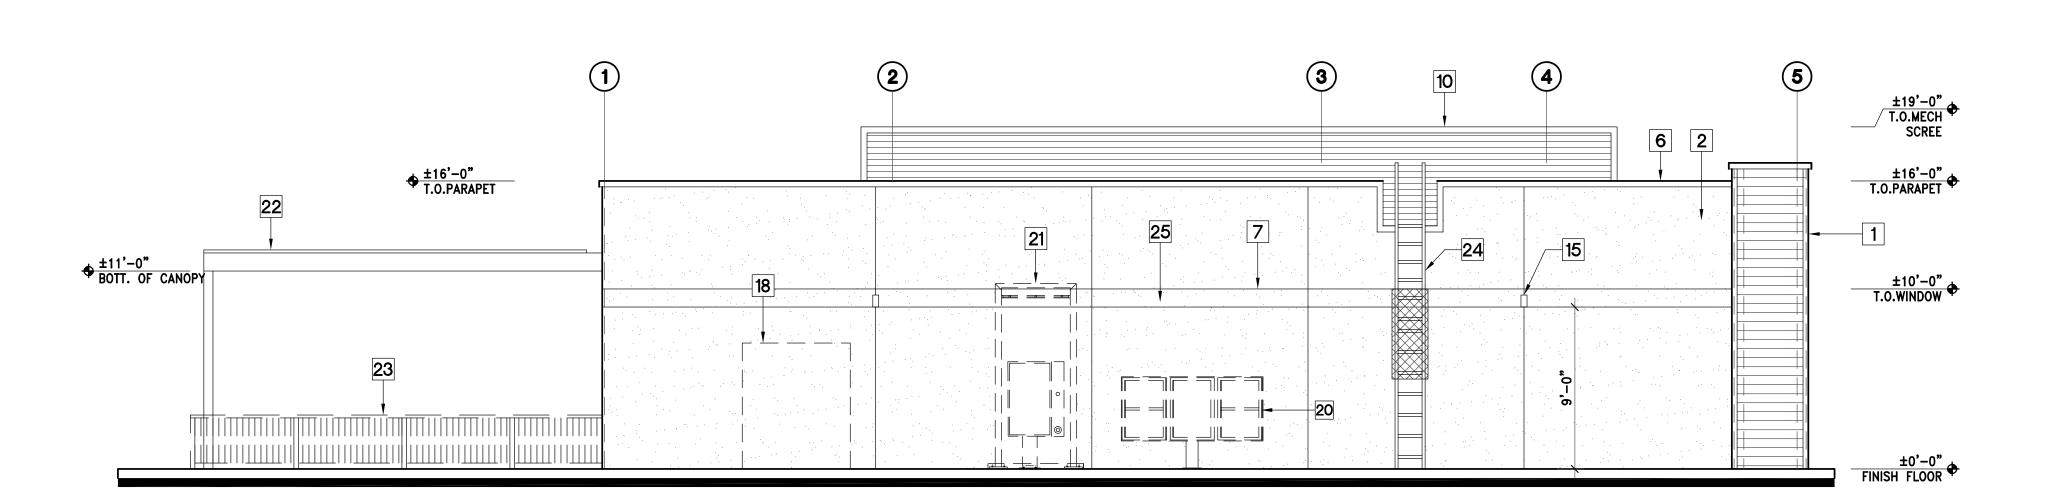

EAST ELEVATION

3/16"=1'-0"

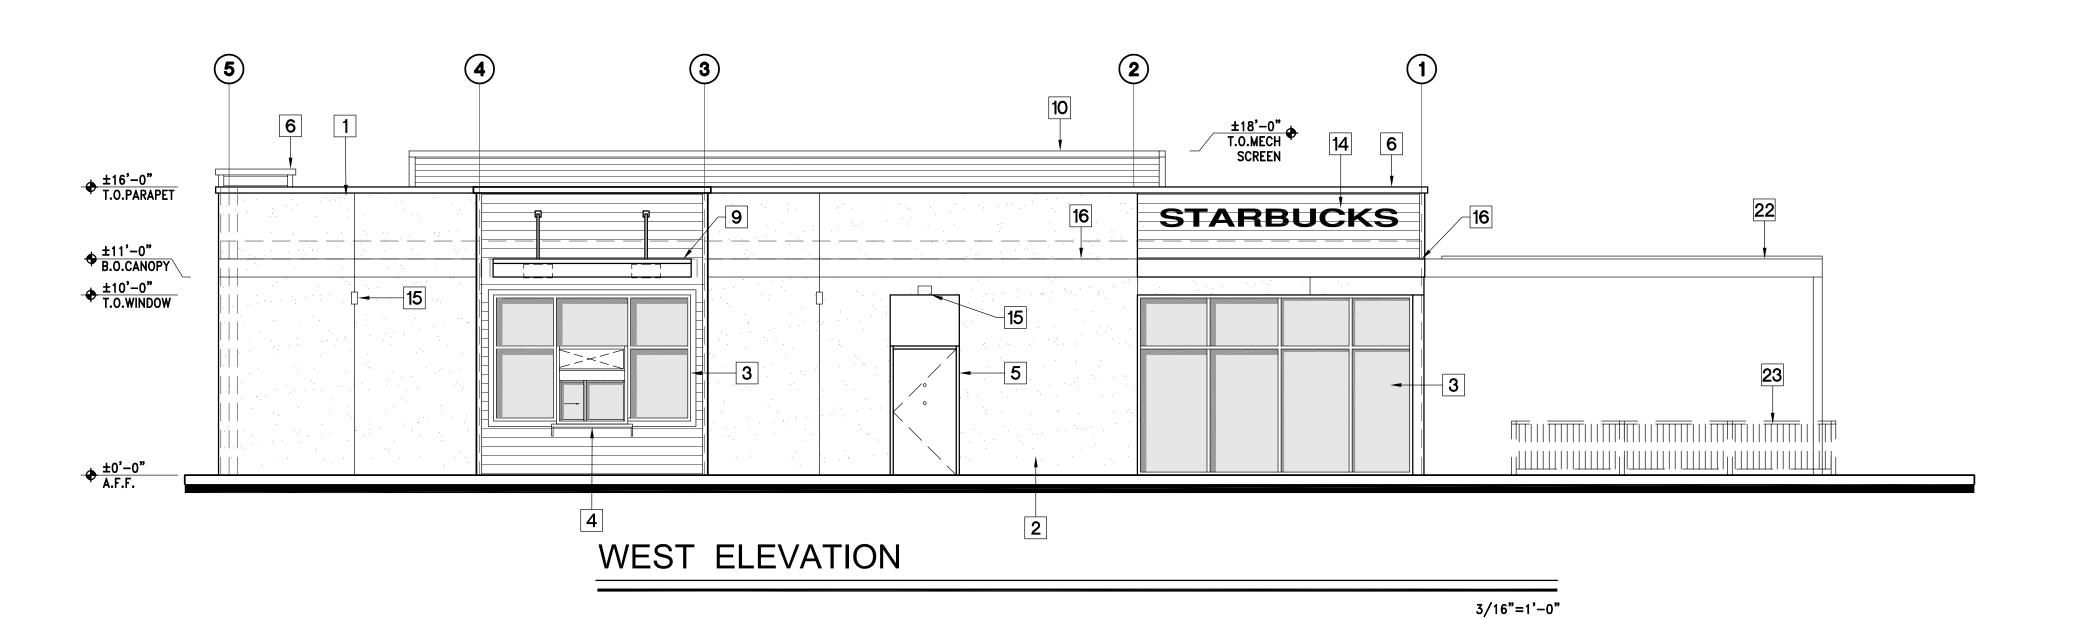



Material Board



SHERWIN WILLIAMS

JAMES HARDIE SMOOTH PLANK "TIMBER BARK"

SW 7004 "SNOWBOUND"





SHERWIN WILLIAMS SW 7069 "IRON ORE"



NORTH ELEVATION



SOUTH ELEVATION



SOUTH ELEVATION



WEST ELEVATION

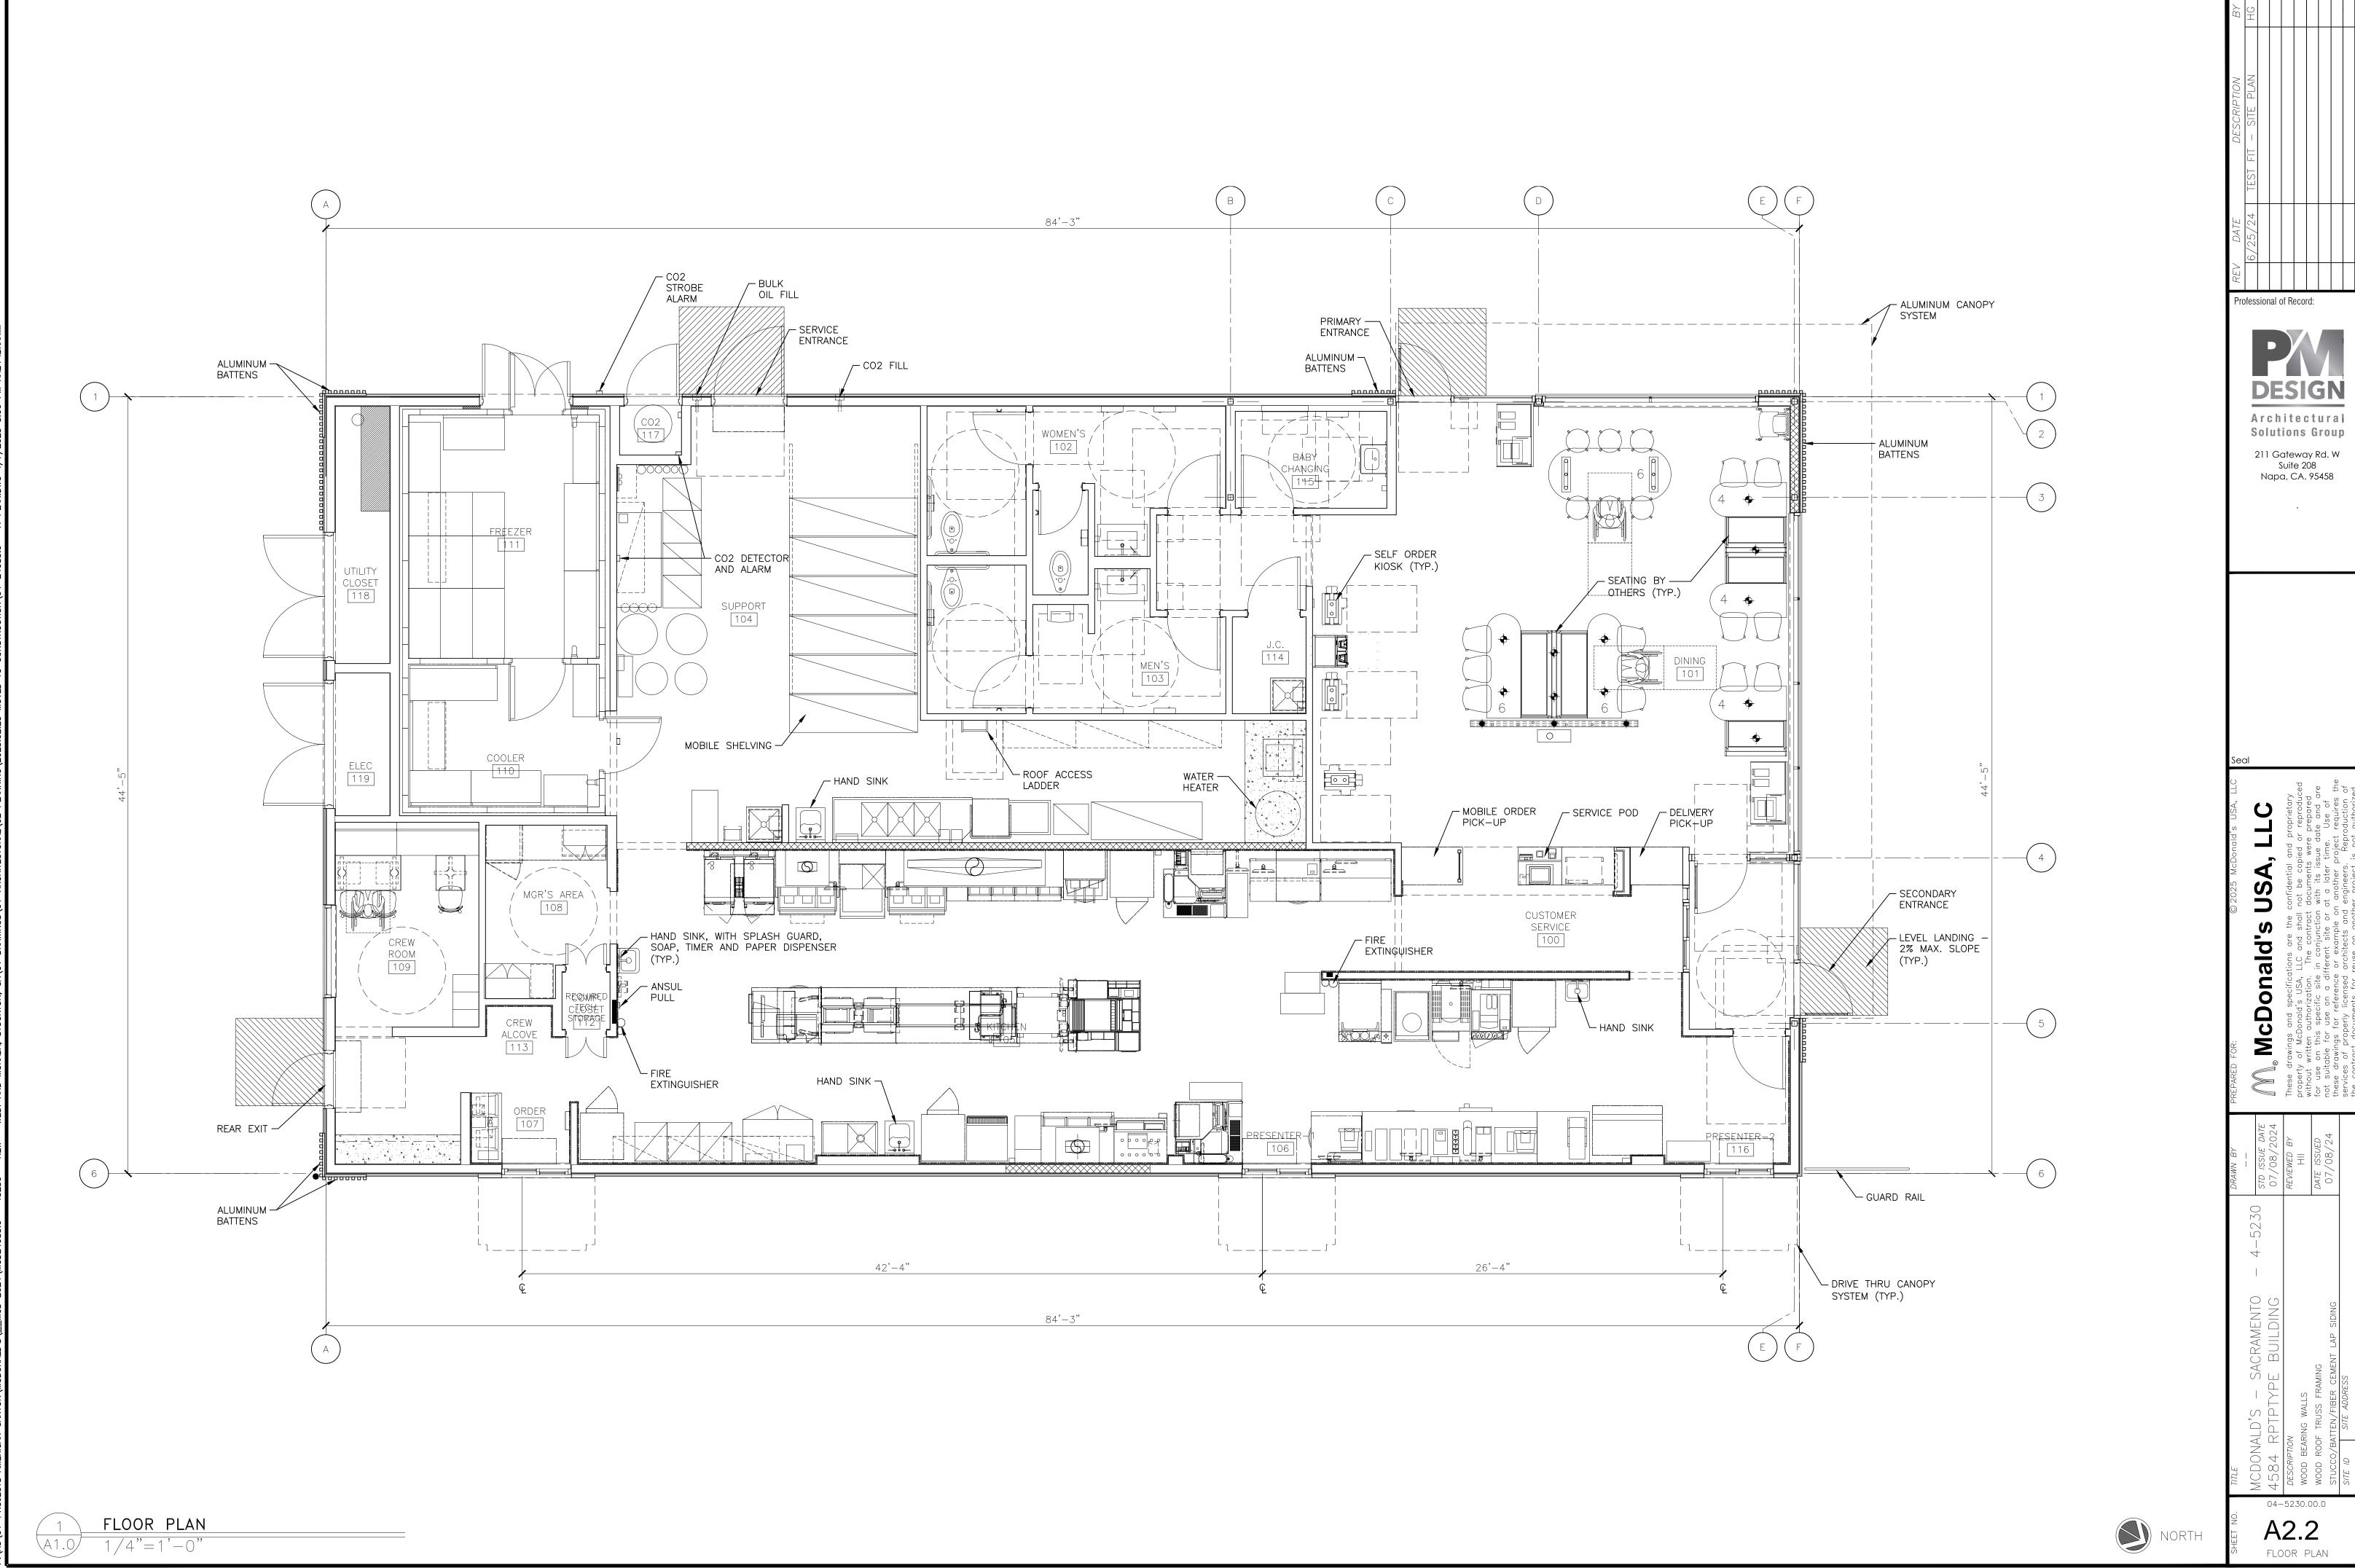


EXHIBIT 2


Professional of Record:


Architectural Solutions Group

211 Gateway Rd. W Suite 208 Napa, CA. 95458

04-5230.00.0

FLOOR PLAN

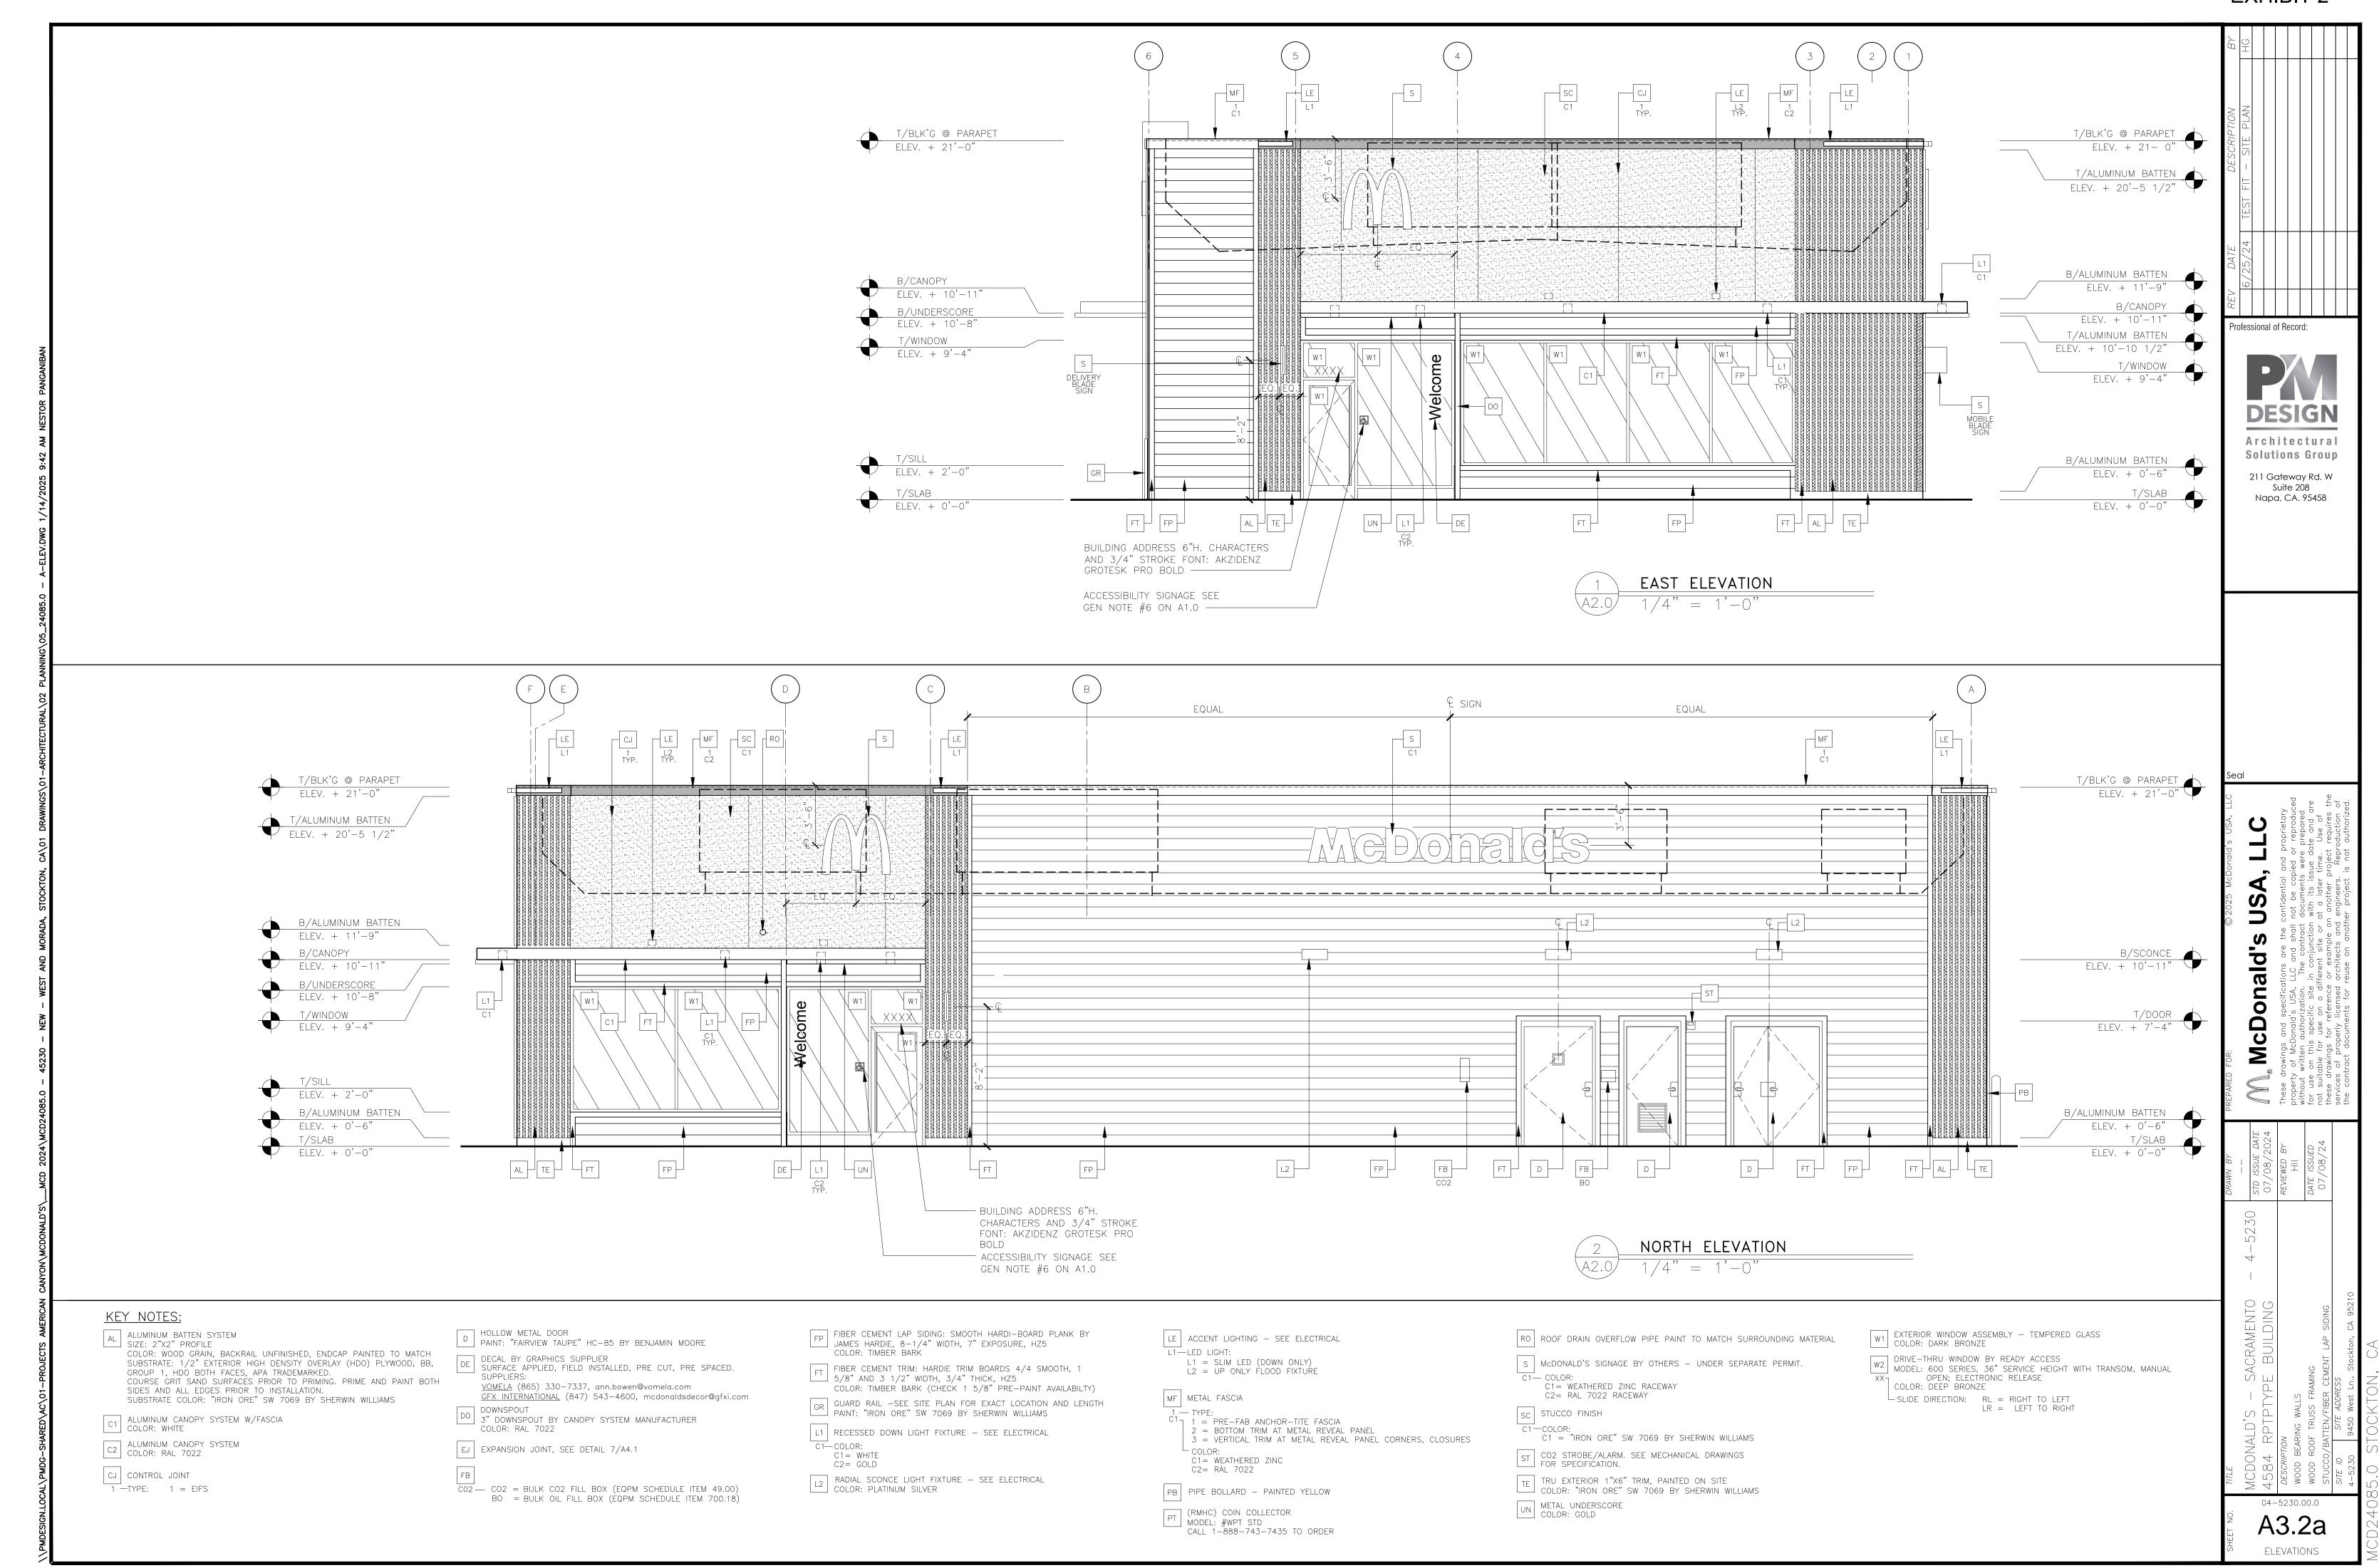

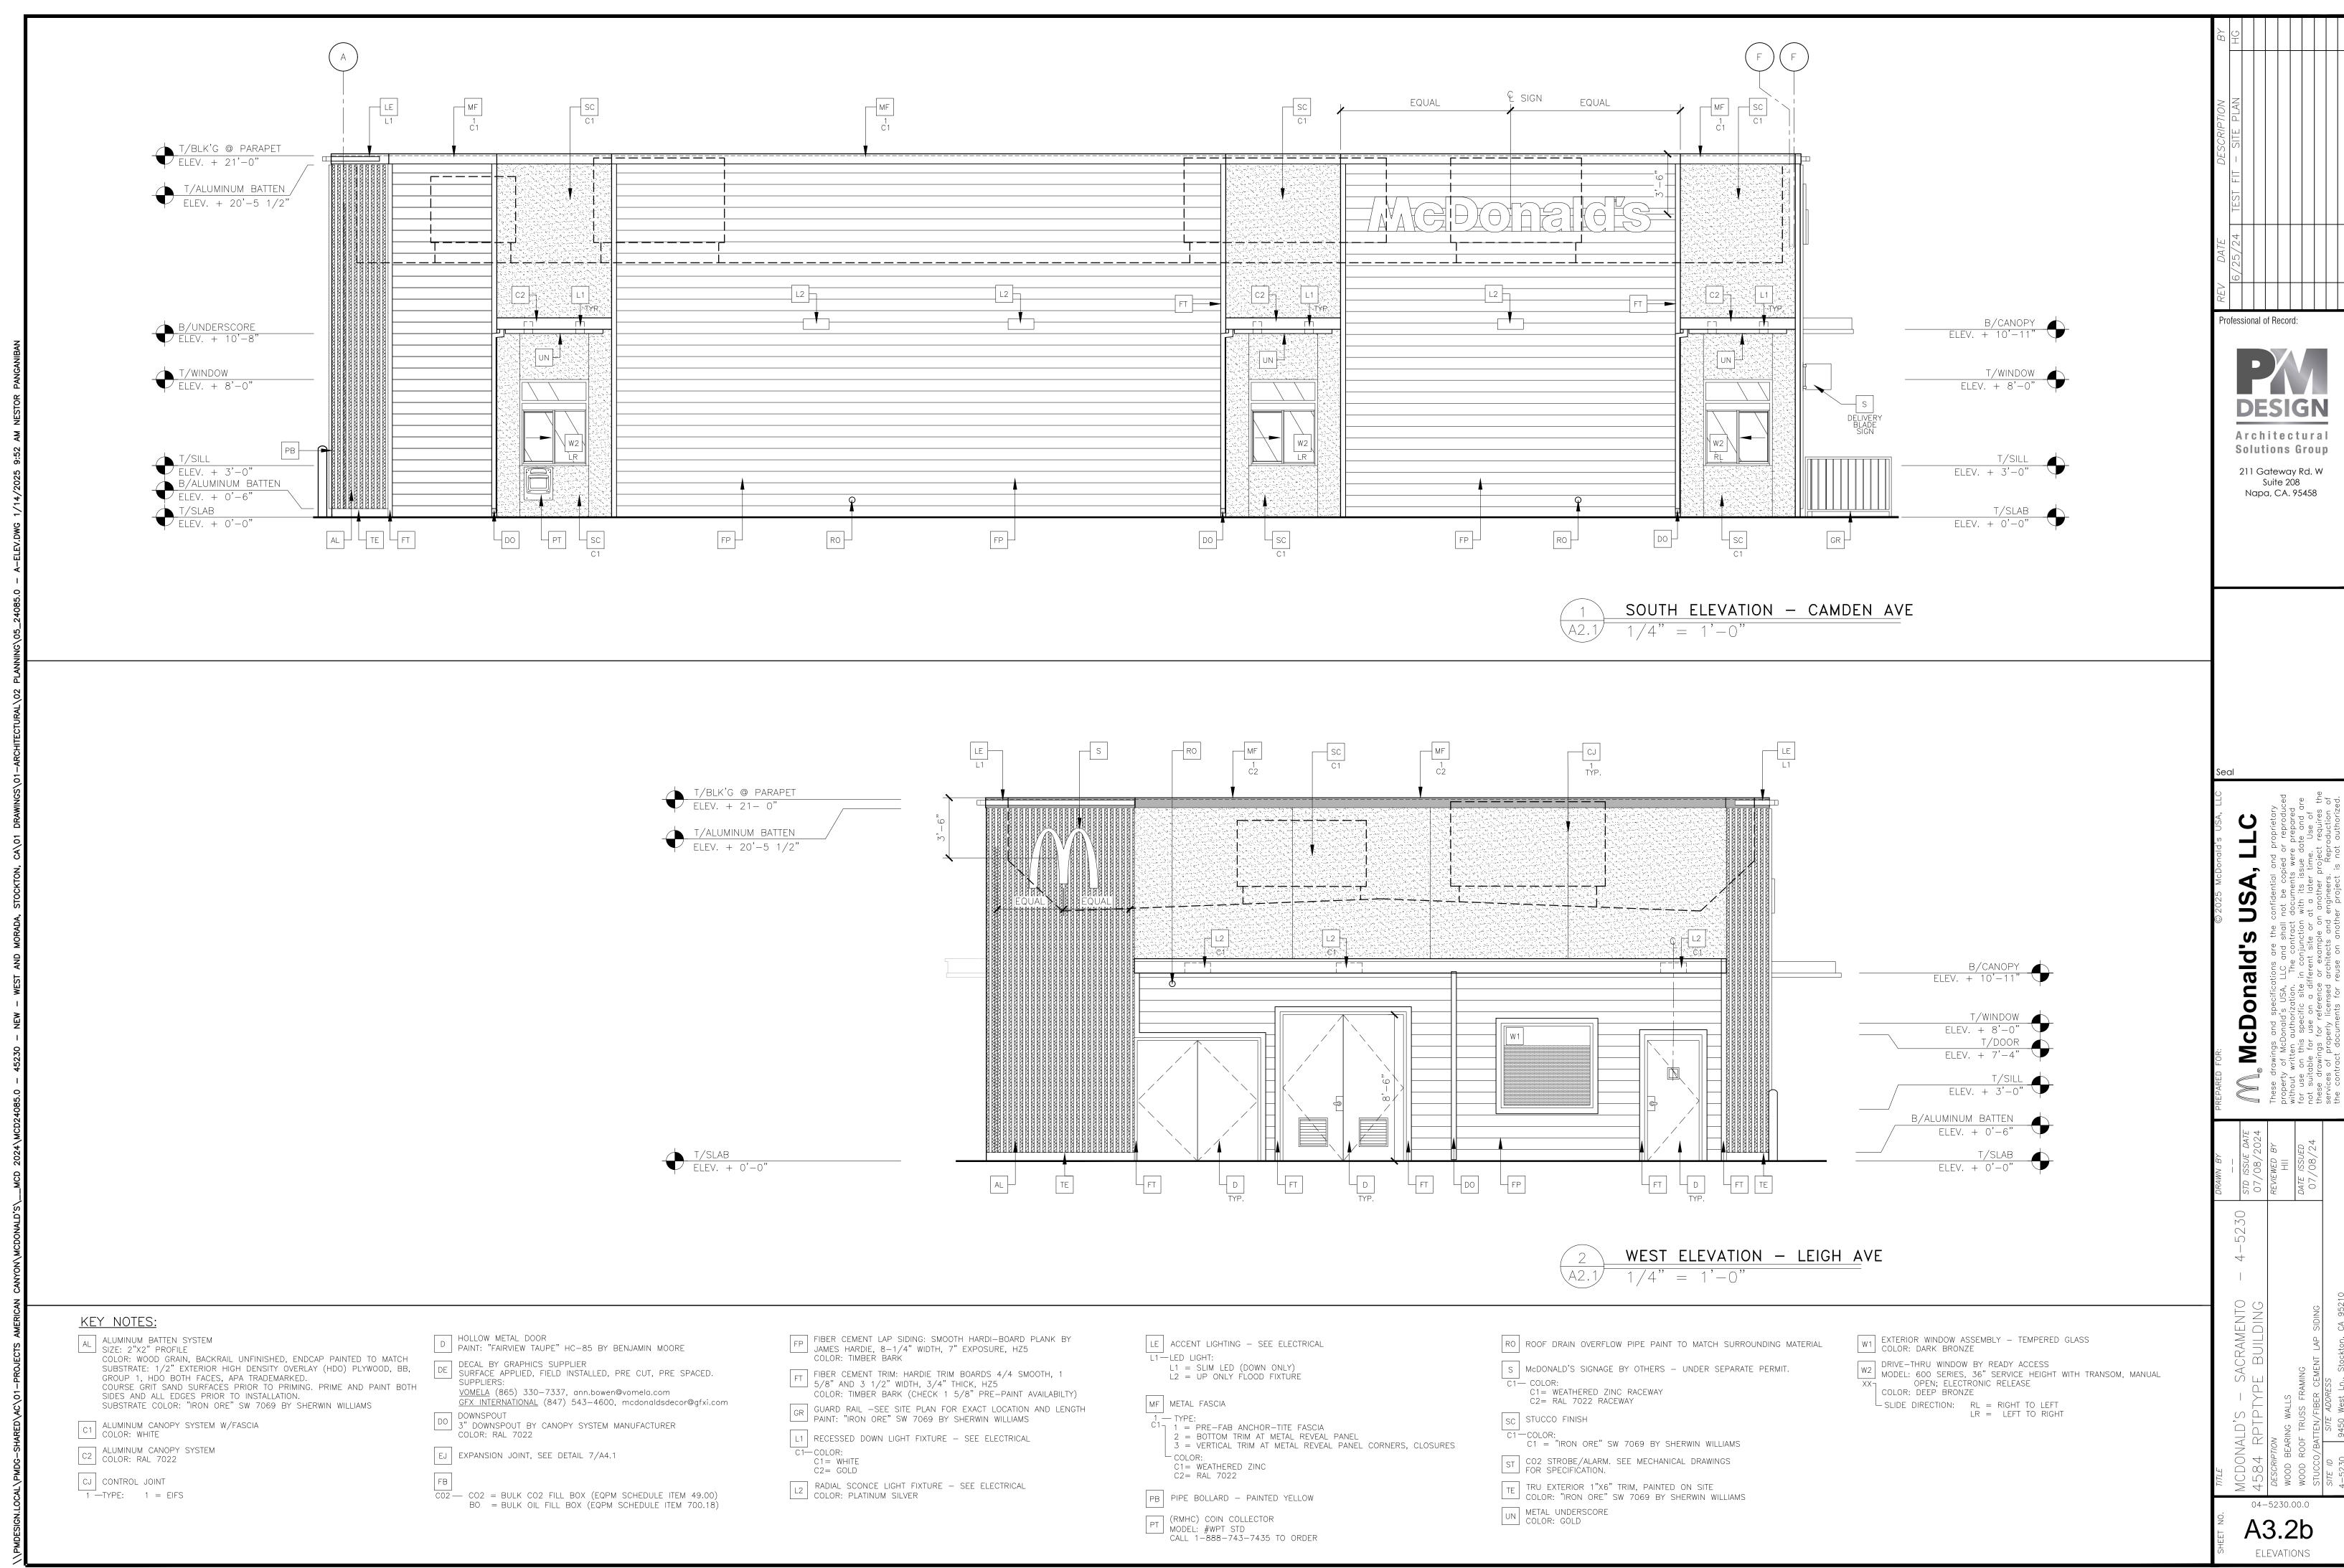



FRONT ELEVATION






























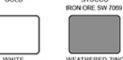
























DRIVE THRU ELEVATION





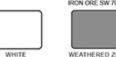



















REAR ELEVATION


























Design Group

1915 Carolina Ave.

Clovis CA 93611

PH: 559. 593.9692

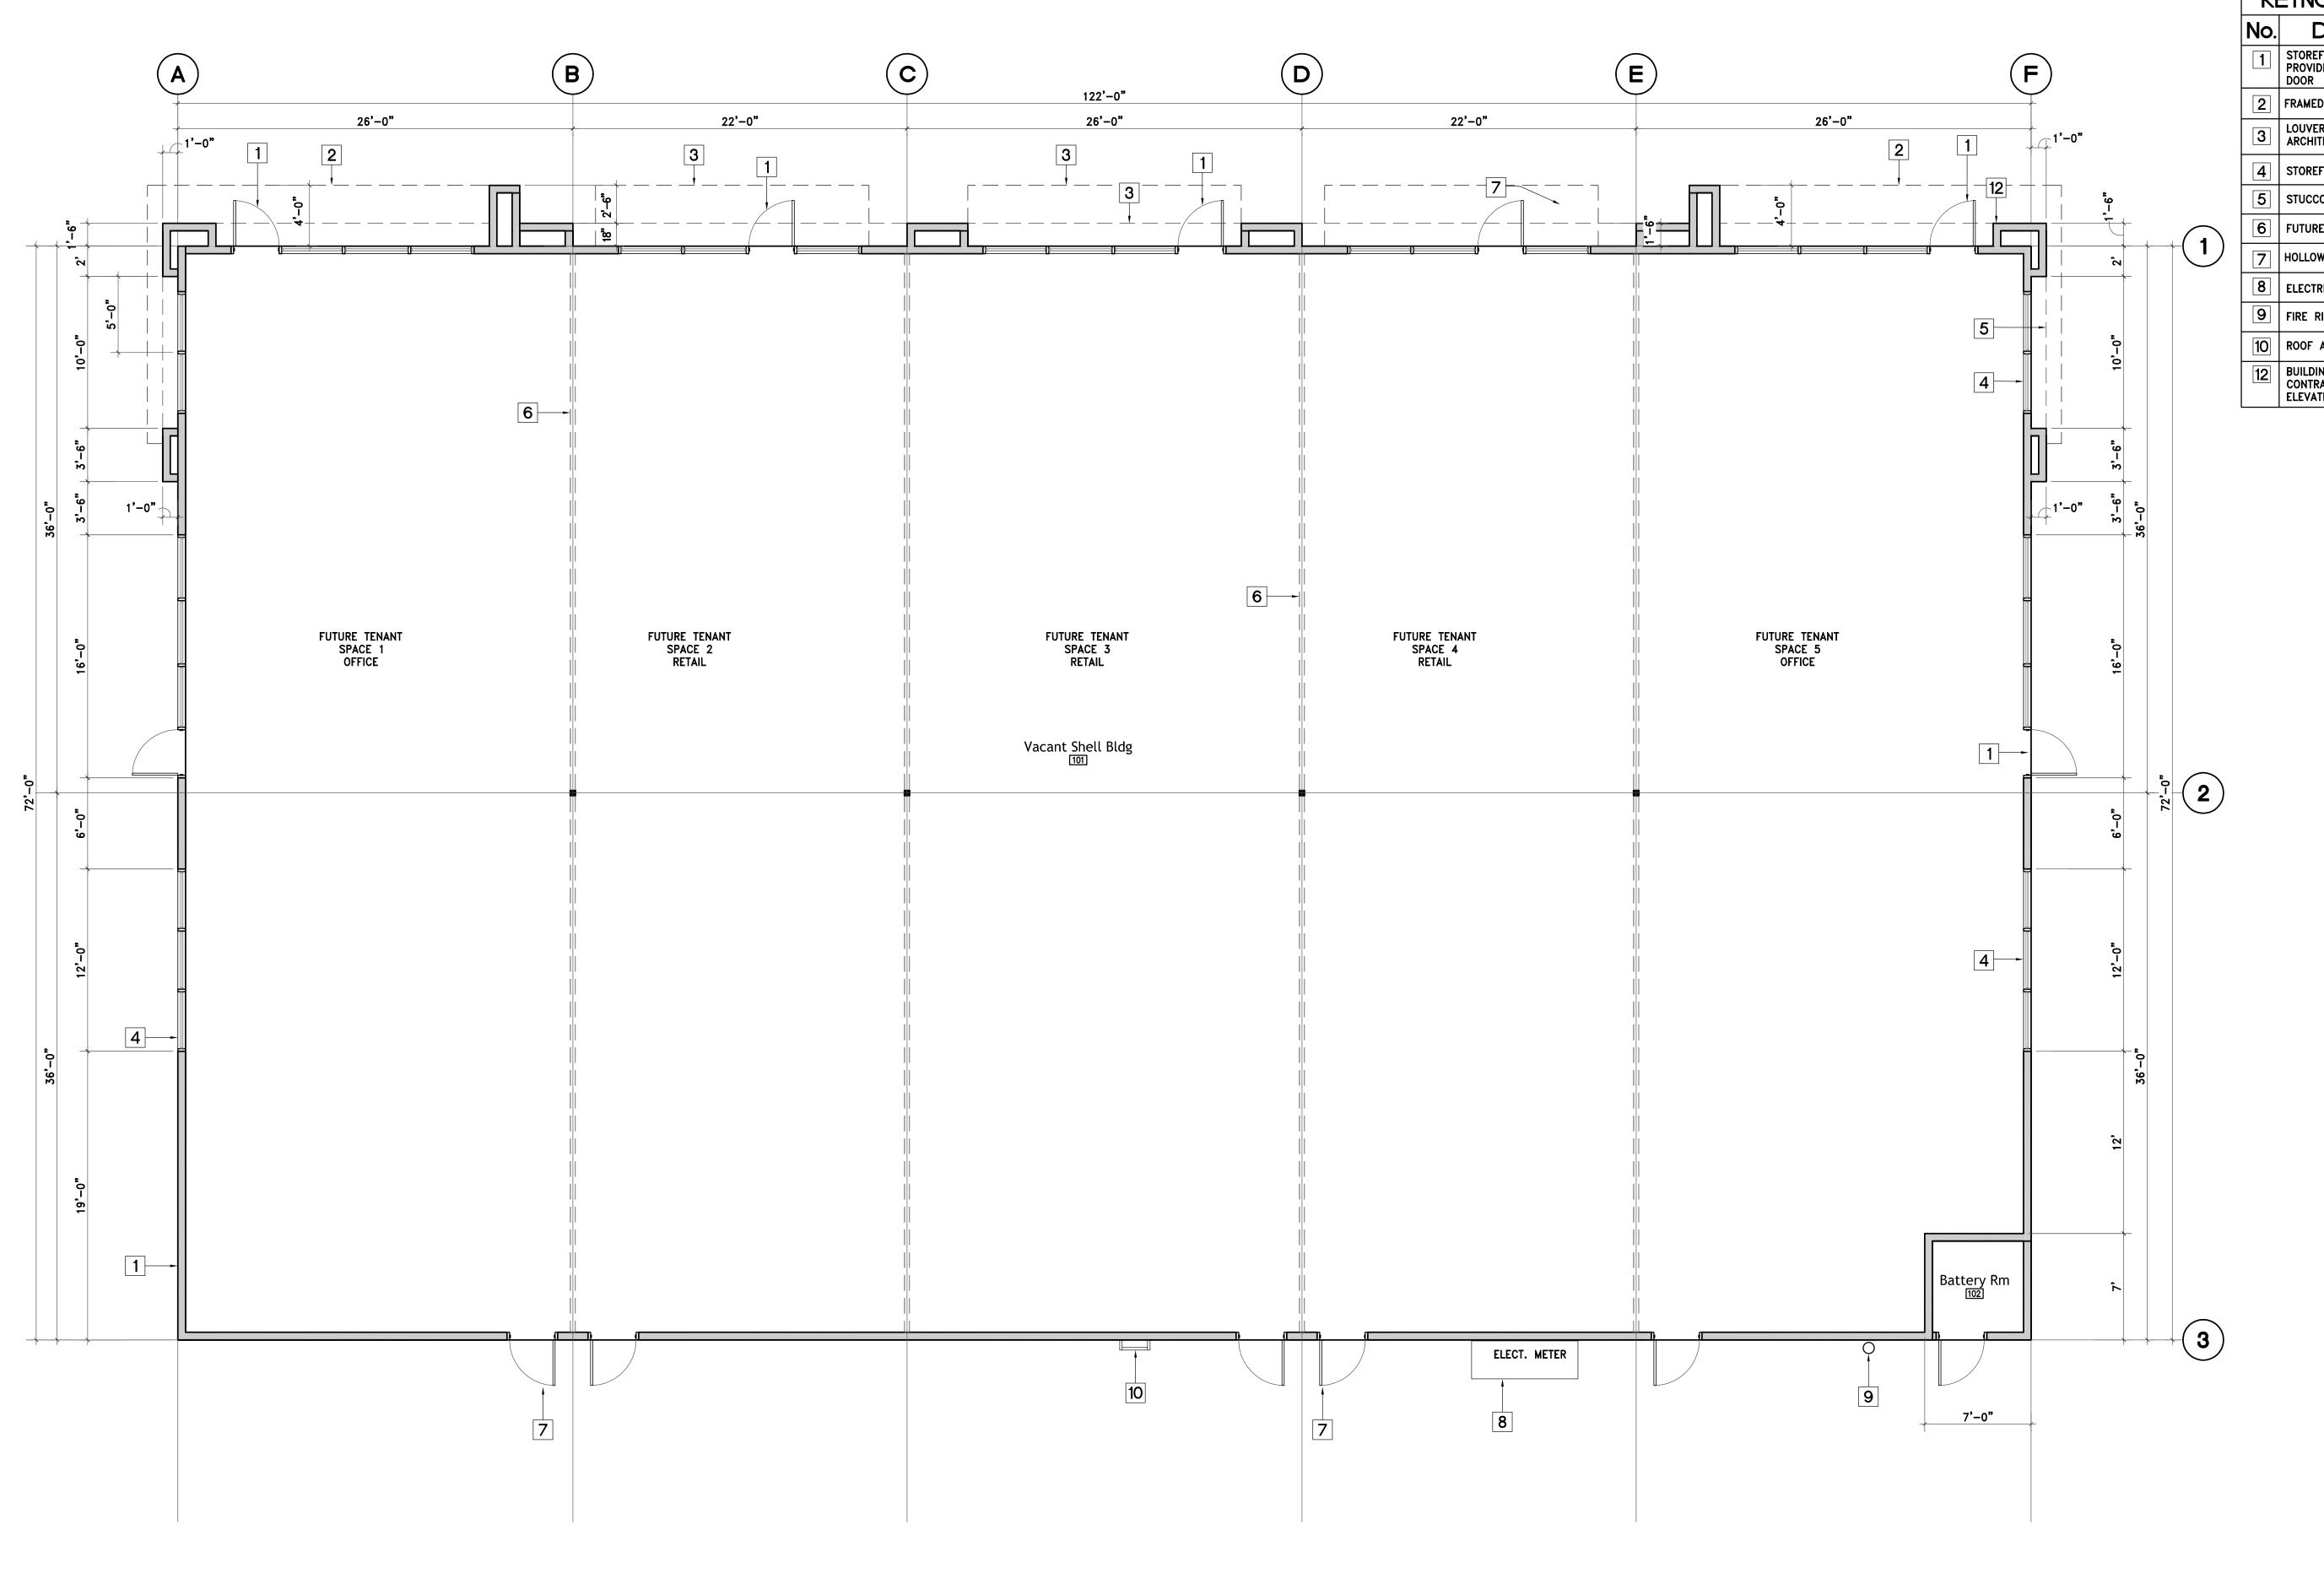

NORTH

1/4"=1'-0"

FLOOR PLAN - Bldg C

NO. Description

STOREFRONT ENTRY DOOR AND WINDOWS PROVIDE LEVEL LANDING AT BOTH SIDES OF DOOR

FRAMED CANTILEVERED SOFFIT

LOUVERED METAL CANOPY MANUF. MAPE ARCHITECTURAL CANOPIES OR APPROVED EQ.

STOREFRONT WINDOWS

STUCCO SOFFIT

FUTURE TENANT DEMISING WALL

HOLLOW METAL DOOR, SEE DOOR SCHEDULE


BELECTRICAL METER CENTER

HORDON ACCESS LADDER

DUILDING ADDRESS SIGN MIN. 12" HIGH ON CONTRASTING BACKGROUND, SEE EXTERIOR ELEVATIONS

Proposed Commercial Center

NEC of West Lane & Morada Lane
Stockton, CA

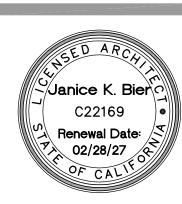

Date: 04.29.25
Drawn By: Susan Jones
Project # 24029

Floor Plan Bldg C

Revisions

SHEET No.

A2.3

EXHIBIT 2

Clovis CA 93611 PH: 559. 593.9692

ane

Morada

ed Commercial (West Lane & In, CA)

enter

PROVIDE LEVEL LANDING AT BOTH SIDES OF 5 STOREFRONT WINDOWS

6 HOLLOW METAL DOOR, SEE DOOR SCHEDULE 7 FRAMED CANTILEVERED SOFFIT

STOREFRONT ENTRY DOOR AND SIDELITE,

PAINTED "TIMBER BARK"

"SNOWBOUND"

"GRAY MATTERS"

8 LOUVERED METAL CANOPY MANUF. MAPE ARCHITECTURAL CANOPIES OR APPROVED EQ.

9 STUCCO SOFFIT

PRE-FINISHED METAL COPING PAINTED SHERWIN WILLIAMS SW 7069 "IRON ORE"

12 STUCCO CONTROL JOINTS

13 DECORATIVE WALL MOUNTED LIGHTS

14 WALL PACK LIGHTS

15 | ELECTRICAL METER CENTER


16 | FIRE RISER


17 ROOF ACCESS LADDER

BUILDING ADDRESS SIGN MIN. 12" HIGH ON CONTRASTING BACKGROUND, SEE EXTERIOR ELEVATIONS BUILDING SIGNAGE IS A SEPARATE SUBMITTAL AND APPROVAL PROCESS SHOWN HERE ONLY

FOR REFERENCE 20 DASHED LINE INDICATES ROOF STRUCTURE

DASHED LINE INDICATES MECH UNITS SCREENED BY PARAPET WALL

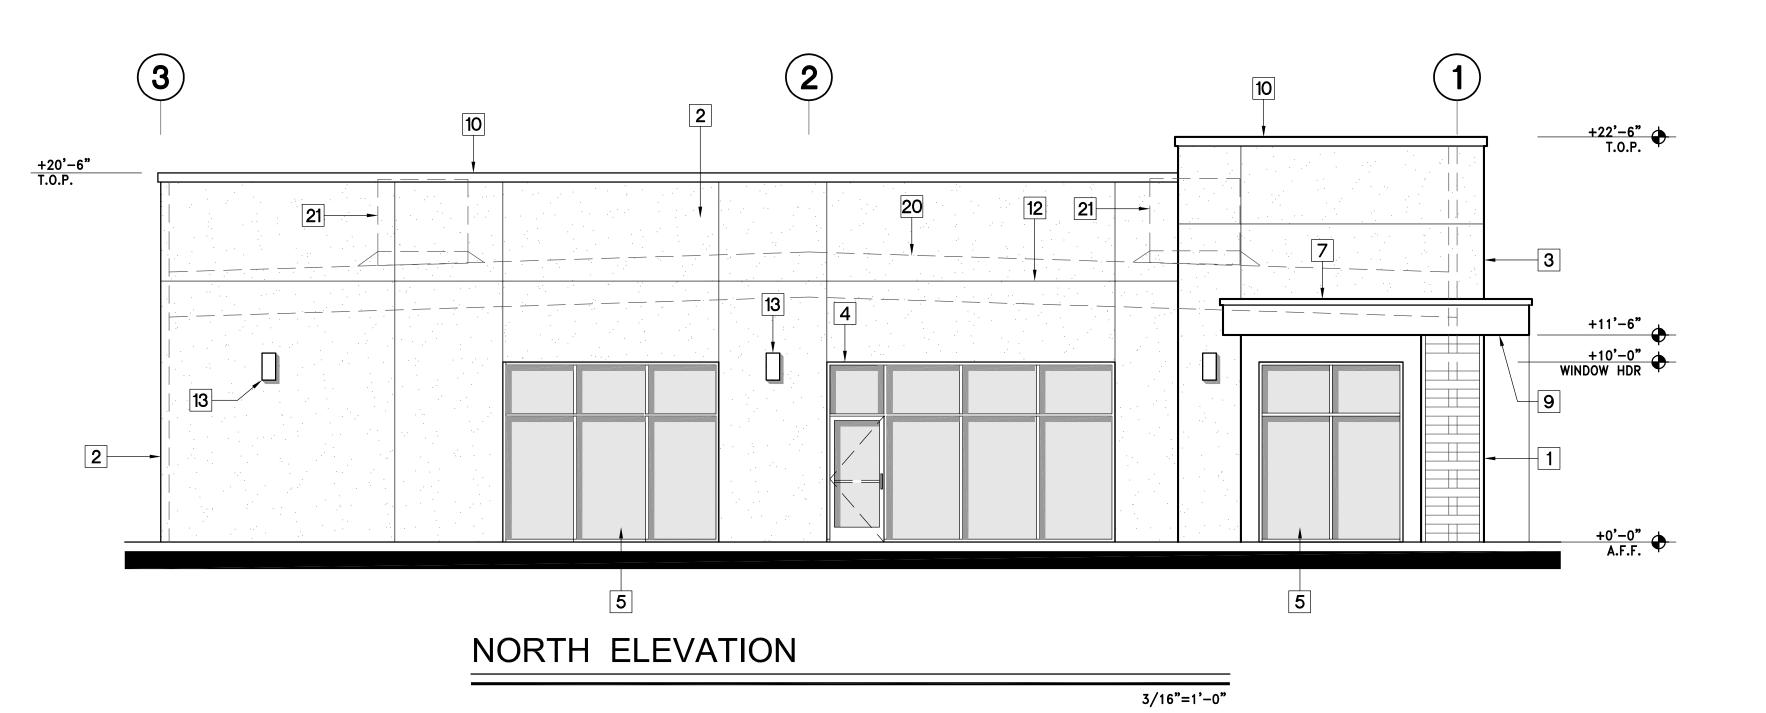

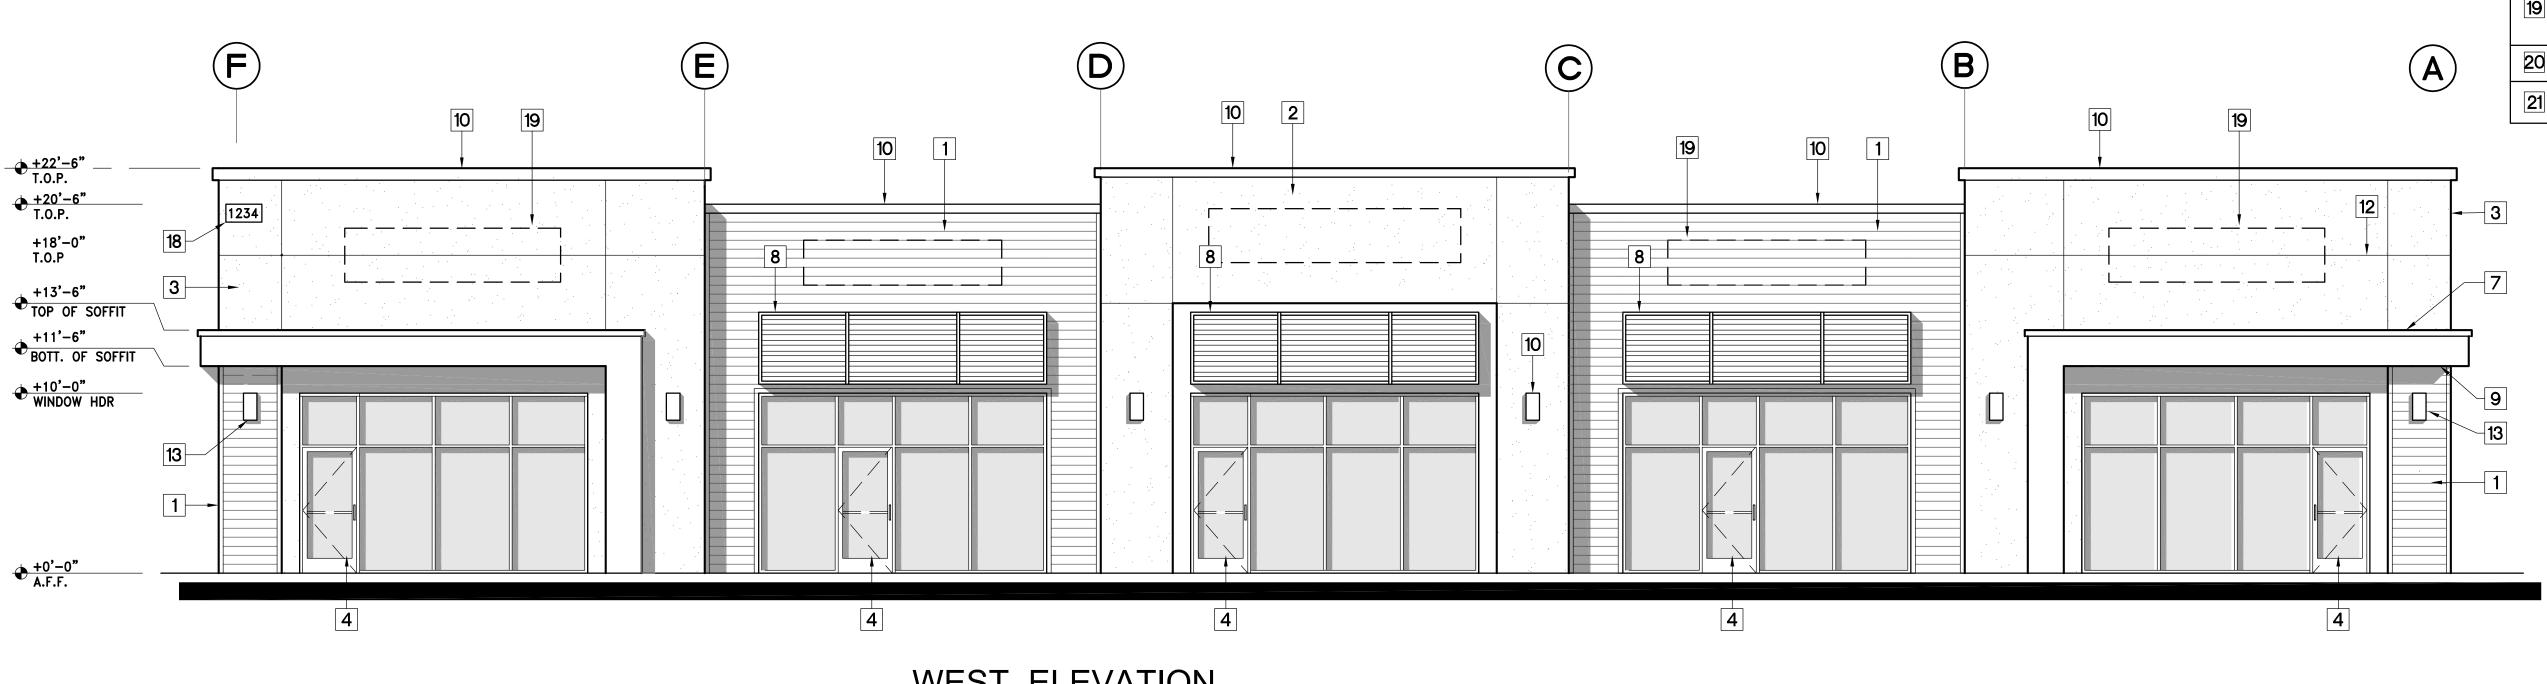

WEST ELEVATION

3/16"=1'-0"


Date: 04.29.25 Drawn By: Susan Jones Project # 24029

Exterior **Elevations** Bldg C

Revisions

SHEET No.

A3.3

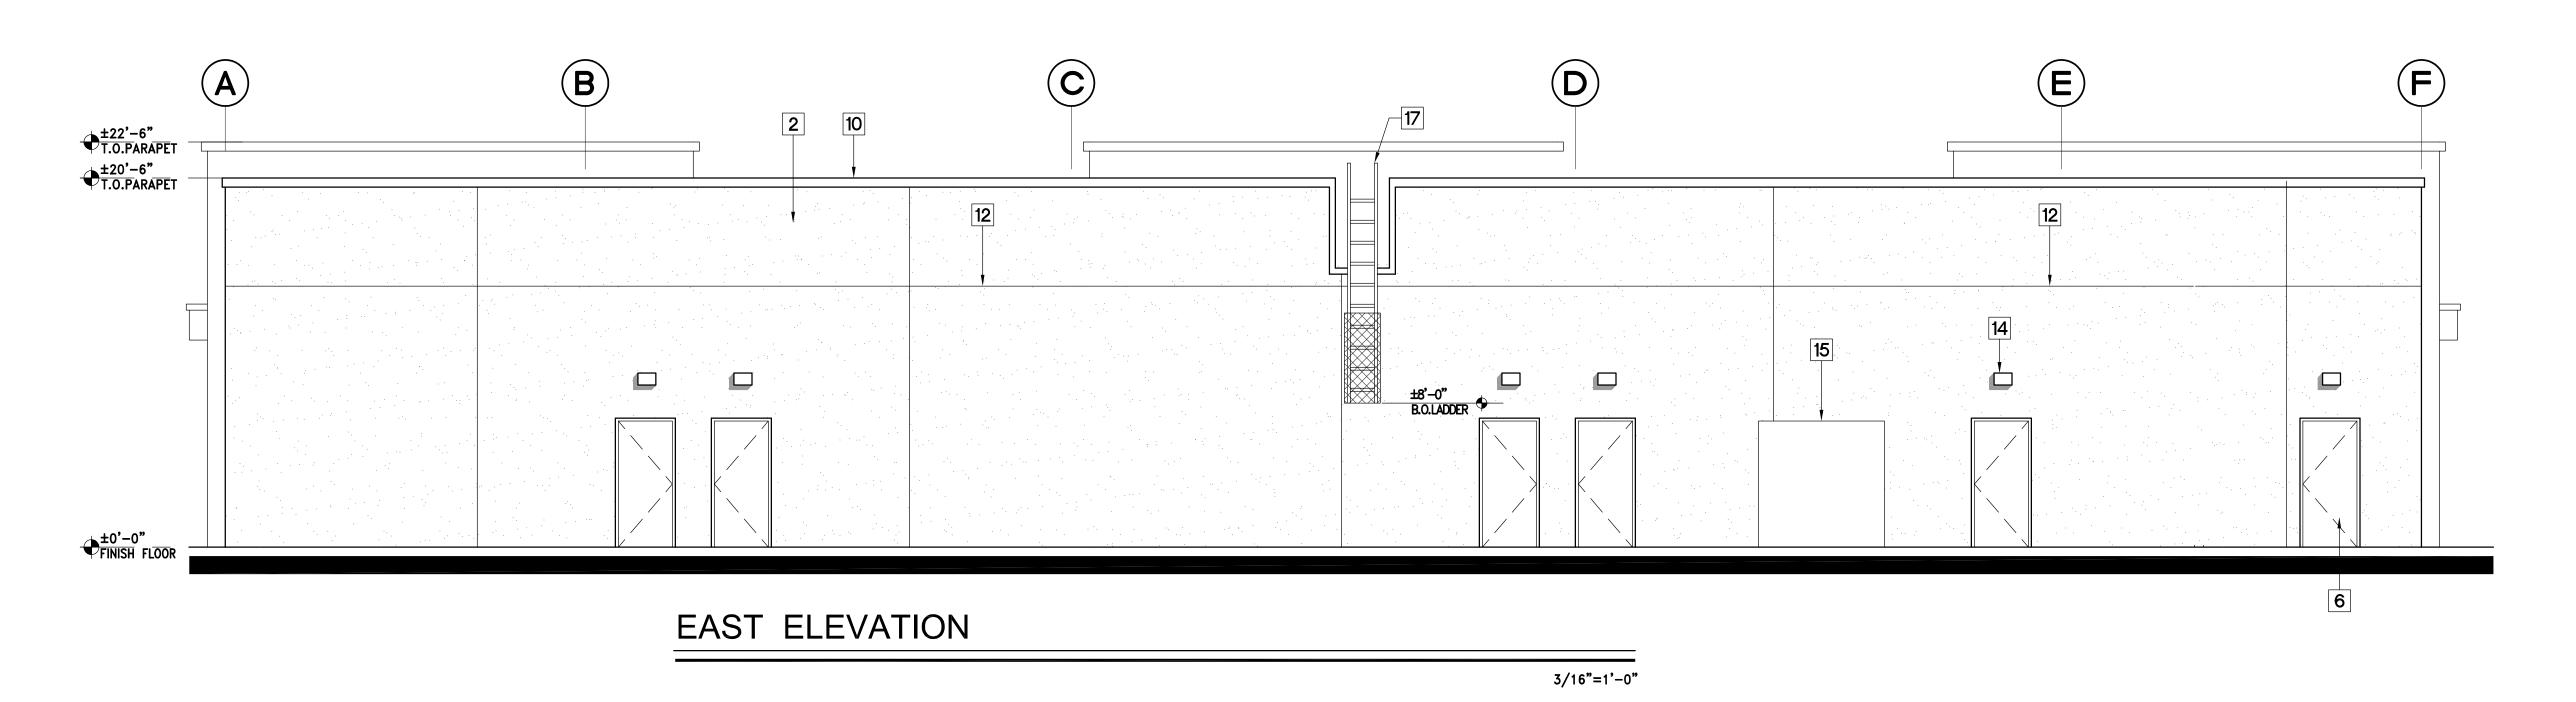

KEYNOTES

No. Description

JAMES HARDIE PLANK SMOOTH FINISH PAINTED "TIMBER BARK"

7/8" CEMENT PLASTER (PAINTED) o/ MTL LATH o/ TYVECK WATER RESISTIVE MEMBRANE o/ SHTHG PAINTED SHERWIN WILLIAMS SW 7004 "SNOWBOUND"

7/8" CEMENT PLASTER (PAINTED) o/ MTL LATH
o/ TYVECK WATER RESISTIVE MEMBRANE o/
SHTHG PAINTED SHERWIN WILLIAMS SW 7066
"GRAY MATTERS"

STOREFRONT ENTRY DOOR AND SIDELITE,
PROVIDE LEVEL LANDING AT BOTH SIDES OF
DOOR

5 STOREFRONT WINDOWS

6 HOLLOW METAL DOOR, SEE DOOR SCHEDULE

7 FRAMED CANTILEVERED SOFFIT

8 LOUVERED METAL CANOPY MANUF. MAPE ARCHITECTURAL CANOPIES OR APPROVED EQ.

9 STUCCO SOFFIT

PRE-FINISHED METAL COPING PAINTED SHERWIN WILLIAMS SW 7069 "IRON ORE"

12 | STUCCO CONTROL JOINTS

13 DECORATIVE WALL MOUNTED LIGHTS

14 WALL PACK LIGHTS

15 ELECTRICAL METER CENTER

16 NOT USED

17 ROOF ACCESS LADDER

BUILDING ADDRESS SIGN MIN. 12" HIGH ON CONTRASTING BACKGROUND, SEE EXTERIOR ELEVATIONS

BUILDING SIGNAGE IS A SEPARATE SUBMITTAL

AND APPROVAL PROCESS SHOWN HERE ONLY FOR REFERENCE

DASHED LINE INDICATES ROOF STRUCTURE

DASHED LINE INDICATES MECH UNITS

SCREENED BY PARAPET WALL

Proposed Commercial Center NEC of West Lane & Morada Lane Stockton, CA

EXHIBIT 2

Design Group

1915 Carolina Ave. Clovis CA 93611

PH: 559. 593.9692



Date: 04.29.25

Drawn By: Susan Jones

Project # 24029

Exterior Elevations Bldg C

Revisions

SHEET No.

A3.4

EXHIBIT 2

Material Board





JAMES HARDIE SHERWIN WILLIAMS SMOOTH PLANK SW 7004 "SNOWBOUND"



SHERWIN WILLIAMS SW 7069 "IRON ORE"



SHERWIN WILLIAMS SW 7066 "GRAY MATTERS"



WEST ELEVATION

EXHIBIT 2



SOUTH ELEVATION



EAST ELEVATION

SYMBOL	BOTANICAL / COMMON NAME	SIZE	WUCOLS	<u>QTY</u>
TREES				
	Geijera parviflora / Australian Willow	15 gal.	Moderate	12
	Lagerstroemia indica x fauriei 'Tuscarora' / Tuscarora Crape Myrtle	15 gal.	Low	17
	Nyssa sylvatica / Tupelo	15 gal.	Moderate	8
	Pistacia chinensis 'Keith Davey' / Keith Davey Chinese Pistache	15 gal.	Low	24



Bark, Mocha Plus (In All Planters)

2 Bioretention

PARKING LOT SHADE CALCULATIONS:

% COVER QTY AREA (SF) TOTAL AREA (SF) 30'-35' Trees (Pistacia c. 'Keith Davey') 962 2 481 20'-30' Trees (Nyssa sylvatica) 707 4,242 354 15'-20' Trees (Geijera parviflora, Lagerstroemia x. 'Tuscarora') 18 314 2 157 50%


TOTAL PARKING LOT AREA = 30,195 SF TOTAL SHADE AREA (per carports and trees) = 15,372 SF SHADE CALCULATION % IN 15 YEARS = 50%



PLANTING NOTES

- 1. CONTRACTOR SHALL BE RESPONSIBLE FOR THE INSTALLATION OF ALL MATERIAL APPEARING ON THE PLAN.
- 2. CONTRACTOR SHALL NOT WILLFULLY PROCEED WITH CONSTRUCTION AS DESIGNED WHEN IT IS OBVIOUS THAT UNKNOWN OBSTRUCTIONS AND/OR GRADE DIFFERENCES EXIST THAT MAY NOT HAVE BEEN KNOWN DURING DESIGN. SUCH CONDITIONS SHALL BE IMMEDIATELY BROUGHT TO THE ATTENTION OF LANDSCAPE CONNECTION, INC. THE CONTRACTOR SHALL ASSUME FULL RESPONSIBILITY FOR ALL NECESSARY REVISIONS DUE TO THE FAILURE TO GIVE SUCH NOTIFICATION.
- 3. CONTRACTOR SHALL BE RESPONSIBLE FOR ANY COORDINATION WITH SUBCONTRACTORS AS REQUIRED TO ACCOMPLISH PLANTING OPERATIONS.
- 4. SEE DETAILS AND SPECIFICATIONS FOR PLANTING REQUIREMENTS, MATERIALS AND EXECUTION.
- 5. ALL PLANT MATERIAL SHALL BE APPROVED BY THE OWNER'S AUTHORIZED REPRESENTATIVE PRIOR TO INSTALLATION.
- 6. FINAL LOCATION OF ALL PLANT MATERIALS SHALL BE SUBJECT TO THE APPROVAL OF THE OWNER'S AUTHORIZED REPRESENTATIVE.
- 7. CONTRACTOR SHALL NOTIFY OWNER'S AUTHORIZED REPRESENTATIVE 48 HOURS PRIOR TO COMMENCEMENT OF WORK TO COORDINATE PROJECT OBSERVATION SCHEDULES.
- 8. SEE DETAILS AND SPECIFICATIONS FOR STAKING METHOD, PLANT PIT DIMENSIONS AND BACKFILL REQUIREMENTS.
- 9. IF CONFLICTS ARISE BETWEEN SIZE OF AREAS AND PLANS, CONTRACTOR SHALL CONTACT LANDSCAPE CONNECTION, INC. FOR RESOLUTION. FAILURE TO MAKE SUCH CONFLICTS KNOWN TO LANDSCAPE CONNECTION, INC. WILL RESULT IN CONTRACTOR'S RESPONSIBILITY TO RELOCATE THE MATERIALS AT NO EXPENSE TO OWNER.
- 10. NO PLANTING SHALL BE DONE UNTIL INSTALLATION OF THE IRRIGATION SYSTEM IS COMPLETED, FINAL GRADES HAVE BEEN ESTABLISHED, PLANTING AREAS HAVE BEEN PROPERLY GRADED AND SOIL PREPARED, AND THE WORK APPROVED BY LANDSCAPE CONNECTION, INC.
- 11. ALL EXISTING TREES TO REMAIN SHALL BE PROTECTED FROM DAMAGE DUE TO CONSTRUCTION.
- 12. THE CONTRACTOR SHALL BE RESPONSIBLE FOR REPLACEMENT AND RECONDITIONING THE EXISTING LANDSCAPE DAMAGED BY THIS CONSTRUCTION CONTRACT. REPLACEMENT AND RECONDITIONING THE EXISTING LANDSCAPE WILL INCLUDE BUT NOT BE NECESSARILY LIMITED TO: TURF ESTABLISHMENT (RIPPING, SOIL PREPARATION, SOIL CONDITIONING, FINE GRADING AND SEEDING); TREE, SHRUB, AND GROUNDCOVER REPLACEMENT, ETC.
- 13. LANDSCAPE AREAS TO BE ROUGH GRADED PLUS OR MINUS A TENTH OF A FOOT.
- 14. A MINIMUM 3" LAYER OF MULCH SHALL BE APPLIED ON ALL EXPOSED SOIL SURFACES OF PLANTING AREAS EXCEPT IN TURF AREAS, CREEPING OR ROOTING GROUNDCOVERS, OR DIRECT SEEDING APPLICATIONS WHERE MULCH IS CONTRAINDICATED.
- 15. LANDSCAPE CONTRACTOR SHALL INSTALL 10 LF (CENTERED ON TREES) OF 24" DEEP ROOT BARRIERS ON ALL TREES WITHIN 8' OF CURB/SIDEWALK.
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LANDSCAPE CONNECTION, INC. **DESIGN BUILD**

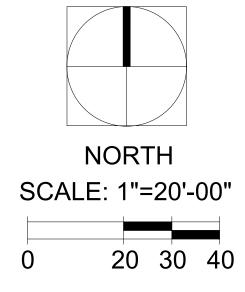

HOPE FITE LANDSCAPE DESIGNER

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> SCALE: AS SHOWN DATE: 1-13-25 DRAWN BY: HF


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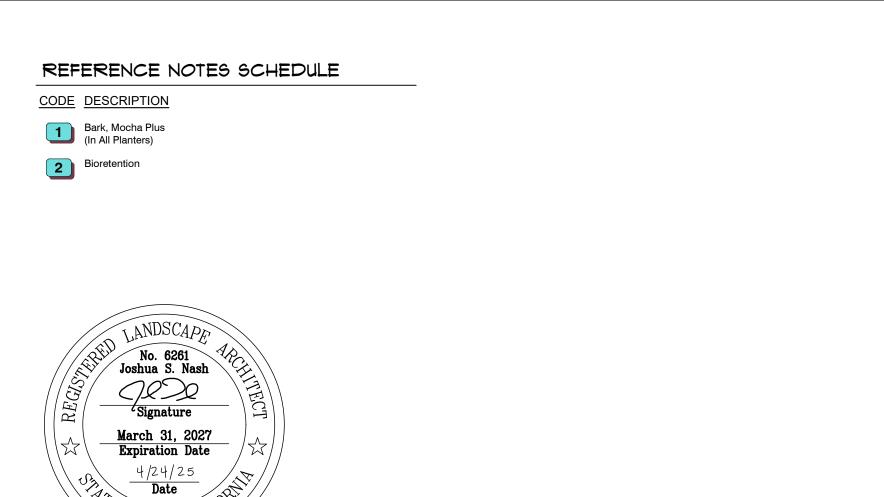
PROJECT NUMBER: 25-105

SHEET IDENTIFICATION NUMBER



SHEET X OF X




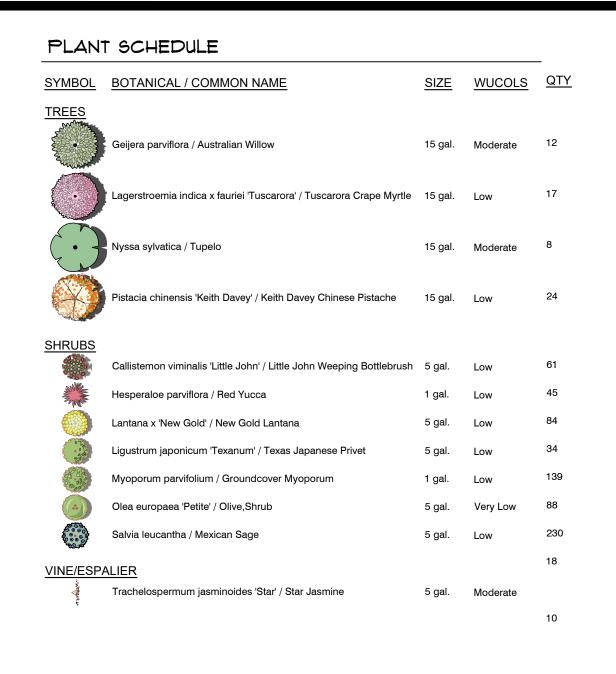

WATER EFFICIENCY LANDSCAPE ORDINANCE: Project: The Stockton Project NEC of West Lane & Morada Lane Stockton, CA. Project Type: Commercial Water Supply: POTABLE Project Applicant: Landscape Connection, INC. (Landscape Designer, Bryon Bramwell) Phone: (559) 323-8139 Email: bryon@landscapeconnection.org MAWA = $(ETo) (0.62) [(0.45 \times LA) + (1-ETAF \times SLA)]$ Maximum Applied Water Allowance (MAWA): 342,308 gallons per year Evapotranspiration Rate (ETo): 49.1 inches per year 0.62: Conversion factor to gallons 0.45: ET adjustment factor (ETAF) Landscape Area (LA) including SLA: 24,988 SF 0.45: Additional water allowance for SLA Special Landscape Area (SLA): 0 SF ETWU = (ETo) (0.62) (PF x HA / IE) Estimated Total Water Use (ETWU): 275,756 gallons per year Evapotranspiration Rate (ETo): 49.1 inches per year 0.62: Conversion factor to gallons Plant Factor (PF) from WUCOLS: 0-0.3 for Low Water Use Plants; 0.4-0.6 for Medium Water Use Plants; 0.7-1.0 for High Water Use Plants 0.8 for Turf Grass Hydrozone Area (HA): 132.22 SF Medium Water Use Bubbler 805.1 SF Low Water Use Bubbler 7.583.83 SF Medium Water Use Drip 14,911.85 SF Low Water Use Drip 14,911.85 SF Bioretention Low Water Use Avg. Irrigation Efficiency (IE): 0.81 for Bubblers 0.81 for Drip 0.75 for Spray Heads Irrigation Type
Medium Water Bubblers
 PF
 HA
 IE
 PF x HA / IE

 0.5
 132.22 SF
 0.81
 81.62
 Low Water Bubblers 0.2 805.1 SF 0.81 198.79 0.5 7,583.83 SF 0.81 4,681.38 Medium Water Drip Low Water Use Drip 0.2 14,911.85 SF 0.81 3,681.94 0.2 1,555 SF 0.75 414.67 Total PF x HA / IE = 9,058.39 Bioretention Low Water "I HAVE COMPLIED WITH THE CRITERIA OF THE WATER EFFICIENT LANDSCAPE


REQUIREMENTS ORDINANCE 15-28, AND APPLIED THEM ACCORDINGLY FOR THE EFFICIENT USE OF WATER IN THE IRRIGATION AND LANDSCAPE DESIGN PLAN." DATE 01/14/25

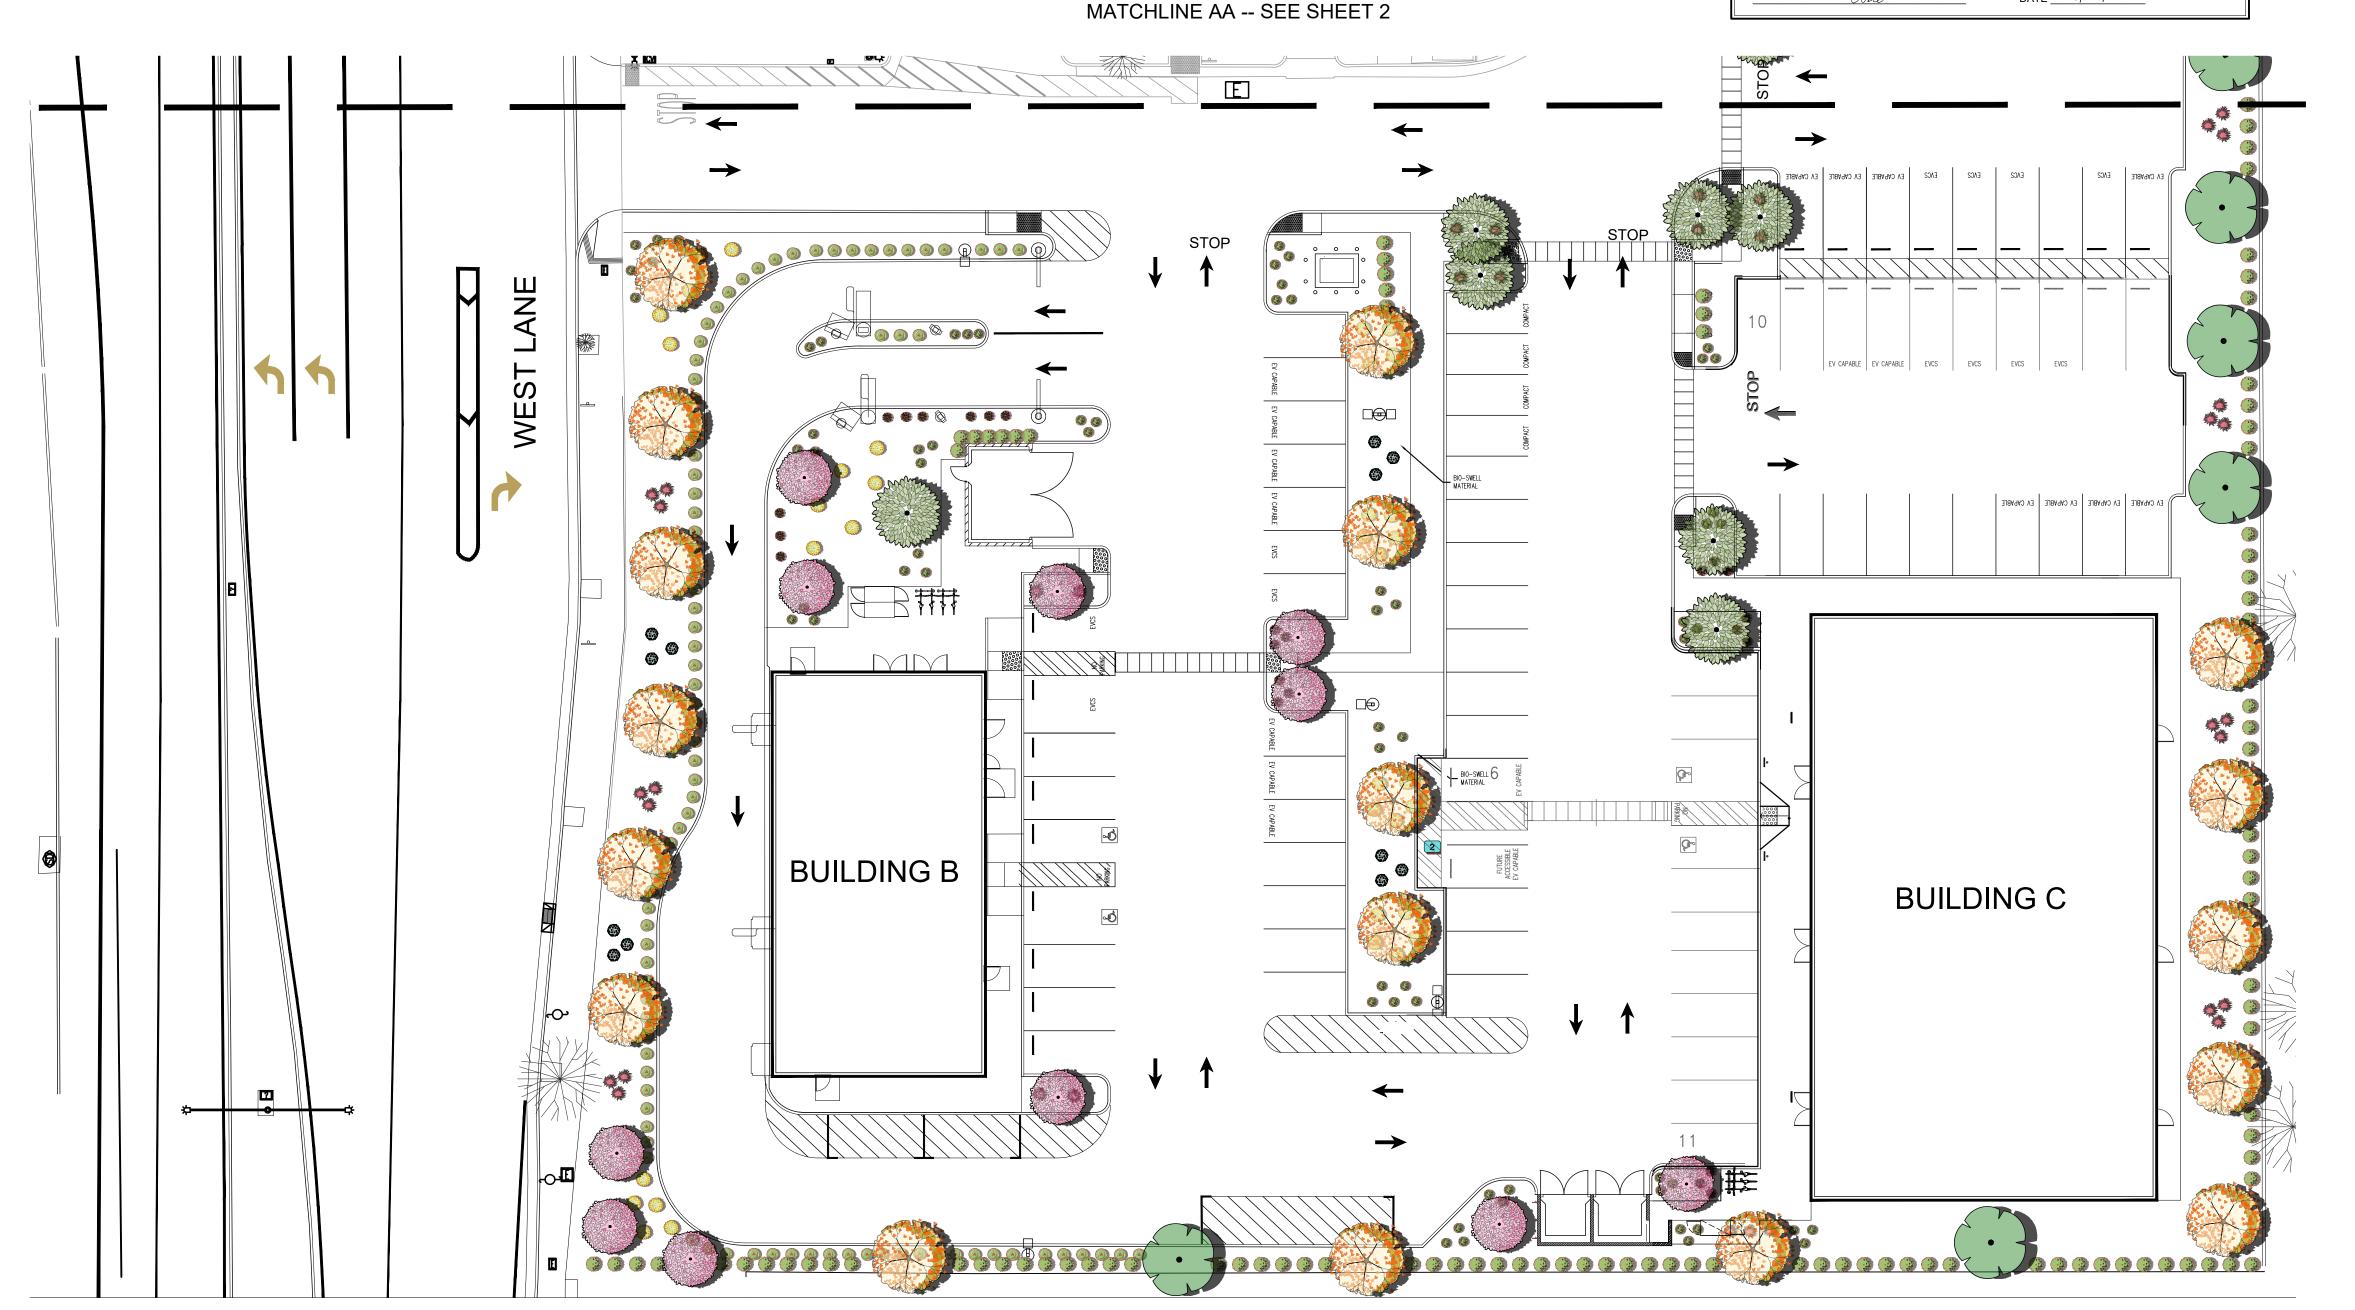

PLANTING NOTES

- 1. CONTRACTOR SHALL BE RESPONSIBLE FOR THE INSTALLATION OF ALL MATERIAL APPEARING ON THE PLAN.
- 2. CONTRACTOR SHALL NOT WILLFULLY PROCEED WITH CONSTRUCTION AS DESIGNED WHEN IT IS OBVIOUS THAT UNKNOWN OBSTRUCTIONS AND/OR GRADE DIFFERENCES EXIST THAT MAY NOT HAVE BEEN KNOWN DURING DESIGN. SUCH CONDITIONS SHALL BE IMMEDIATELY BROUGHT TO THE ATTENTION OF LANDSCAPE CONNECTION, INC. THE CONTRACTOR SHALL ASSUME FULL RESPONSIBILITY FOR ALL NECESSARY REVISIONS DUE TO THE FAILURE TO GIVE SUCH NOTIFICATION.
- 3. CONTRACTOR SHALL BE RESPONSIBLE FOR ANY COORDINATION WITH SUBCONTRACTORS AS REQUIRED TO ACCOMPLISH PLANTING OPERATIONS.
- 4. SEE DETAILS AND SPECIFICATIONS FOR PLANTING REQUIREMENTS, MATERIALS AND EXECUTION.
- 5. ALL PLANT MATERIAL SHALL BE APPROVED BY THE OWNER'S AUTHORIZED REPRESENTATIVE PRIOR TO INSTALLATION.
- 6. FINAL LOCATION OF ALL PLANT MATERIALS SHALL BE SUBJECT TO THE APPROVAL OF THE OWNER'S AUTHORIZED REPRESENTATIVE.
- 7. CONTRACTOR SHALL NOTIFY OWNER'S AUTHORIZED REPRESENTATIVE 48 HOURS PRIOR TO COMMENCEMENT OF WORK TO COORDINATE PROJECT OBSERVATION SCHEDULES.
- 8. SEE DETAILS AND SPECIFICATIONS FOR STAKING METHOD, PLANT PIT DIMENSIONS AND BACKFILL REQUIREMENTS.
- 9. IF CONFLICTS ARISE BETWEEN SIZE OF AREAS AND PLANS, CONTRACTOR SHALL CONTACT LANDSCAPE CONNECTION, INC. FOR RESOLUTION. FAILURE TO MAKE SUCH CONFLICTS KNOWN TO LANDSCAPE CONNECTION, INC. WILL RESULT IN CONTRACTOR'S RESPONSIBILITY TO RELOCATE THE MATERIALS AT NO EXPENSE TO OWNER.
- 10. NO PLANTING SHALL BE DONE UNTIL INSTALLATION OF THE IRRIGATION SYSTEM IS COMPLETED, FINAL GRADES HAVE BEEN ESTABLISHED, PLANTING AREAS HAVE BEEN PROPERLY GRADED AND SOIL PREPARED, AND THE WORK APPROVED BY LANDSCAPE CONNECTION, INC.
- 11. ALL EXISTING TREES TO REMAIN SHALL BE PROTECTED FROM DAMAGE DUE TO CONSTRUCTION.
- 12. THE CONTRACTOR SHALL BE RESPONSIBLE FOR REPLACEMENT AND RECONDITIONING THE EXISTING LANDSCAPE DAMAGED BY THIS CONSTRUCTION CONTRACT. REPLACEMENT AND RECONDITIONING THE EXISTING LANDSCAPE WILL INCLUDE BUT NOT BE NECESSARILY LIMITED TO: TURF ESTABLISHMENT (RIPPING, SOIL PREPARATION, SOIL CONDITIONING, FINE GRADING AND SEEDING); TREE, SHRUB, AND GROUNDCOVER REPLACEMENT, ETC.
- 13. LANDSCAPE AREAS TO BE ROUGH GRADED PLUS OR MINUS A TENTH OF A FOOT.
- 14. A MINIMUM 3" LAYER OF MULCH SHALL BE APPLIED ON ALL EXPOSED SOIL SURFACES OF PLANTING AREAS EXCEPT IN TURF AREAS, CREEPING OR ROOTING GROUNDCOVERS, OR DIRECT SEEDING APPLICATIONS WHERE MULCH IS CONTRAINDICATED.
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SHEET X OF X

PLANT SCHEDULE

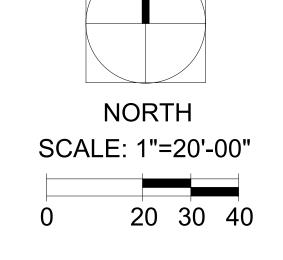

PHOTO

BOTANICAL / COMMON NAME

TREES



Geijera parviflora / Australian Willow



Pistacia chinensis 'Keith Davey' / Keith Davey Chinese Pistache



Lagerstroemia indica x fauriei 'Tuscarora' / Tuscarora Crape Myrtle



Nyssa sylvatica / Tupelo

SHRUBS





Callistemon viminalis 'Little John' / Little John Weeping Bottlebrush



Myoporum parvifolium / Groundcover Myoporum



Hesperaloe parviflora / Red Yucca



Olea europaea 'Petite' / Olive,Shrub



Salvia leucantha / Mexican Sage



Lantana x 'New Gold' / New Gold Lantana



Ligustrum japonicum 'Texanum' / Texas Japanese Privet

VINE/ESPALIER



Trachelospermum jasminoides 'Star' / Star Jasmine