### PROPERTY SUMMARY

35,000 SF TOTAL

PROPERTY APN PROPERTY ADDRESS

PROPERTY SIZE PROPERTY OWNER OWNER ADDRESS

(E) BUILDINGS (E) UTILITIES PROPERTY ZONING

PROPOSED BUILDINGS PROPOSED USE PROPOSED PARKING PROPOSED POWER PROPOSED GAS PROPOSEDFIRE SUPRESSION 903-0007-0004 7979 SOUTH AIRPORT WAY STOCKTON, CA 95206 146,361 SF (3.36 ACRES) **ROBERT J. NIELSEN TRUST** 218 GLORY LILY CT. SAN RAMON, CA 94583 NONE CITY WATER UNZONED (UNZ)


F-1 71 SPACES (3 HANDICAP) 480 VOLT 2000 AMP THREE PHASE SERVICE ABOVE GROUND STORAGE TANK AUTOMATIC FIRE SUPPRESSION SYSTEM

### SCOPE OF WORK

1. GRADE PROPERTY FOR NEW 35,000 SF BUILDING, PARKING LOTS, DRAINAGE, & WATER RETENTION 2. PROVIDE ASPHALT PER PLAN FOR DRIVEWAY & PARKING LOTS 3. PROVIDE 8'-0" TALL PERIMETER FENCE WITH AUTOMATIC GATE AT MAIN ENTRANCE. 4. PROVIDE (N) WATER LINE TO PROPOSED BUILDING FROM (E) CITY LINE 5. PROVIDE 480 VOLT 2,000 AMP POWER SERVICE FROM (E) UNDERGROUND CITY LINE 6. PROVIDE (N) FOUNDATION FOR PROPOSED 35,000 SF PREFABRICATED STRUCTURE. 7. CONSTRUCT 35,000 PREFABRICATED STRUCTURE (GREENHOUSE + PROCESSING) 8. IF REQUIRED BY CITY, PROVIDE AUTOMATIC FIRE SUPPRESSION SYSTEM 9. PROVIDE ELECTRIC FOR 35,000 SF BUILDING + SITE LIGHTING. 10. PROVIDE PLUMBING AND IRRIGATION FOR GREENHOUSE.

## LANDSCAPING

PER REQUEST OF THE STOCKTON PLANNING DEPARTMENT A NEW LANDSCAPE FEATURE IS PROPOSED ALONG THE 10'-0" STRIP OF LAND BETWEEN THE SET-BACK FENCE AND PROPERTY LINE. THE LANDSCAPING WILL CONSISTS OF A SINGLE ROW OF PURPLE HOPSEED BUSH (BOTANICAL NAME: DODENEA VISCOSA PURPUREA) WHICH WILL GROW TO A HEIGHT OF 12'-15' AFTER THREE YEARS.

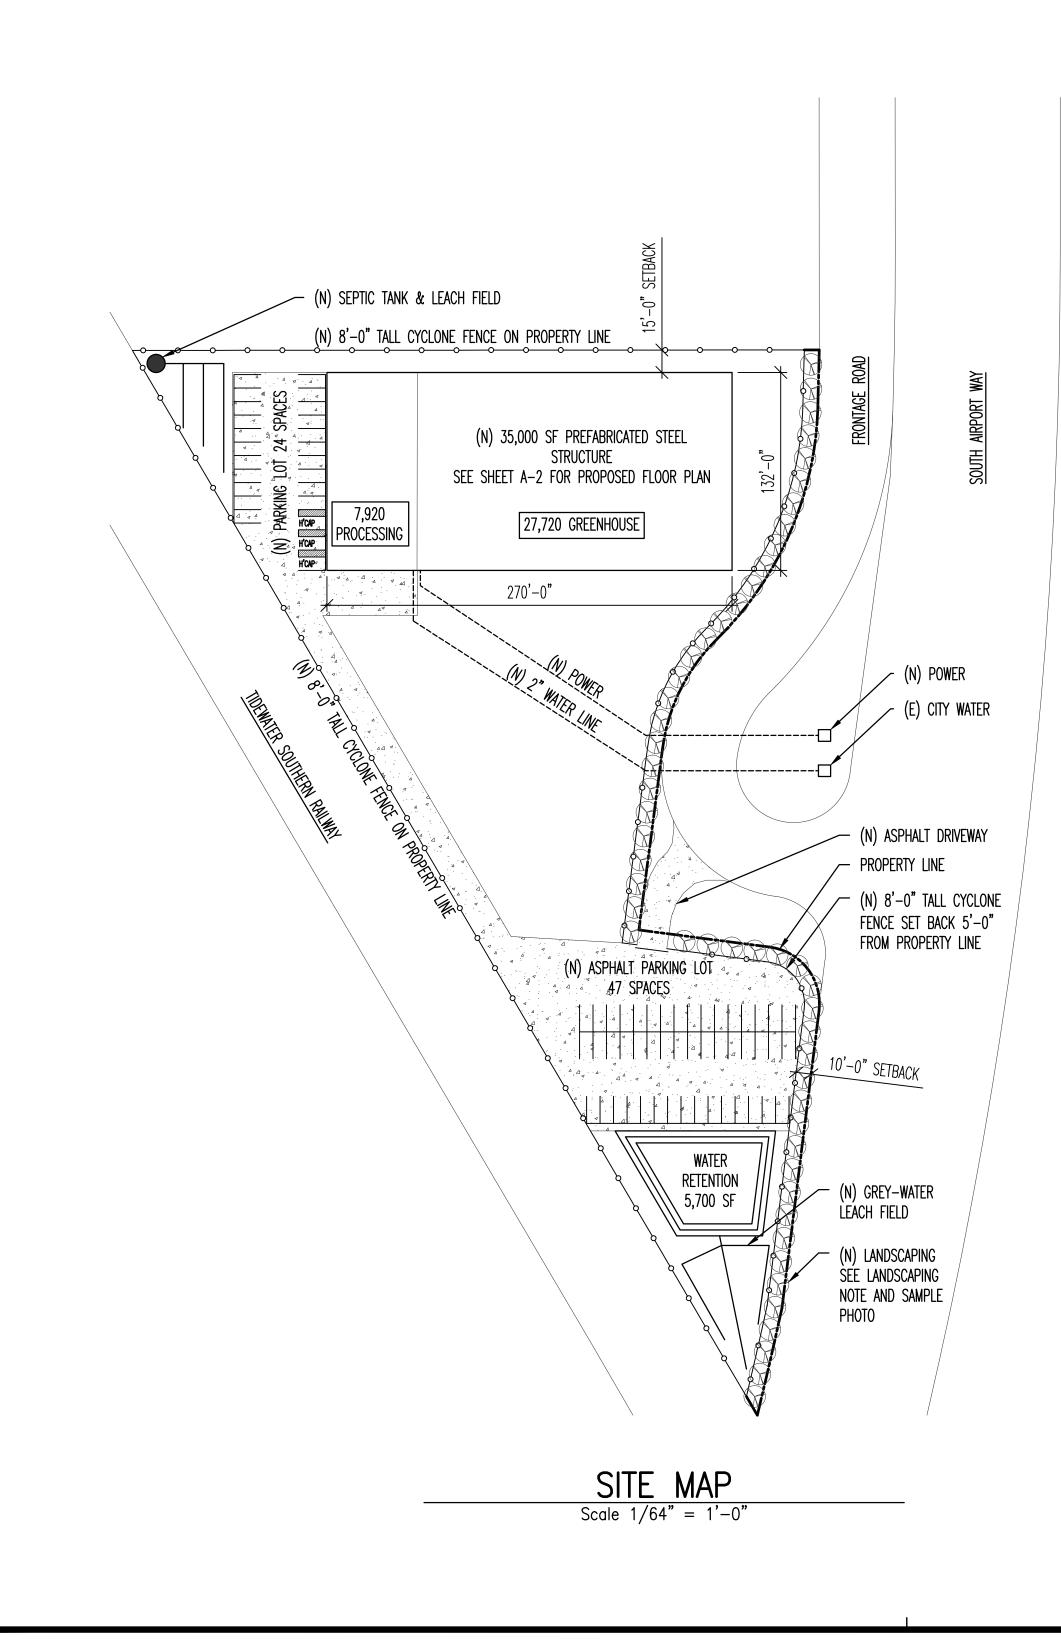

### **DEFERRED ITEMS**

1. GEOTECHNICAL REPORT PREPARED BY ROCKRIDGE GEOTECHNICAL ENGINEERS FOR SOIL BEARING VALUES USED IN FOUNDATION DESIGN.

2. STRUCTURAL CALCULATIONS & DRAWINGS FOR GREENHOUSE DESIGN AND FOUNDATION DESIGN PROVIDED BY GRO-TECH SYSTEMS. 3. CIVIL DESIGN FOR GRADING AND DRAINAGE.

4. POWER UPGRADE DESIGN

5. FIRE SUPPRESSION DESIGN. 6. ELECTRICAL DESIGN

7. PLUMBING DESIGN.

### **COLOR BOARD**

PLEASE SEE SHEET A-2 OF THESE PLANS FOR PHOTOS OF "ALPINE SERIES" GREENHOUSES, WHICH ARE PROPOSED TO BE CONSTRUCTED AT THIS PROJECT SITE. MORE INFORMATION REGARDING THIS GRADE "A" GREENHOUSE CAN BE FOUND AT WWW.GRO-TECHSYSTEMS.COM

# **ONSITE PARKING**

PER SECTION 16.64 OF THE STOCKTON MUNICIPAL CODE INDUSTRY, MANUFACTURING, AND PROCESSING USES MUST PROVIDE 1 ONSITE PARKING SPACE PER 500 SF OF BUILDING SPACE. THIS PROJECT PROPOSES 35,000 SF OF BUILDING SPACE, THUS 70 PARKING SPACES MUST BE PROVIDED AND PER TABLE 3-10 THREE HANDICAP PARKING SPACES MUST BE PROVIDED. THIS PROJECT PROPOSES 71 ONSITE PARKING SPACES WITH 3 HANDICAP SPACES.


#### **DRAWINGS INDEX**

PROPERTY INFO, SITE MAP, CONTEXT MAP BUILDING ELEVATIONS, FLOOR PLAN, SECURITY

# **CONDITIONAL USE PERMIT TO OPERATE 22,000 SF MEDICAL CANNABIS** $\bigcirc$ LIGHT DEPRIVATION GREENHOUSE CULTIVATION AT 7979 SOUTH **AIRPORT WAY, STOCKTON**

A-1

A-2

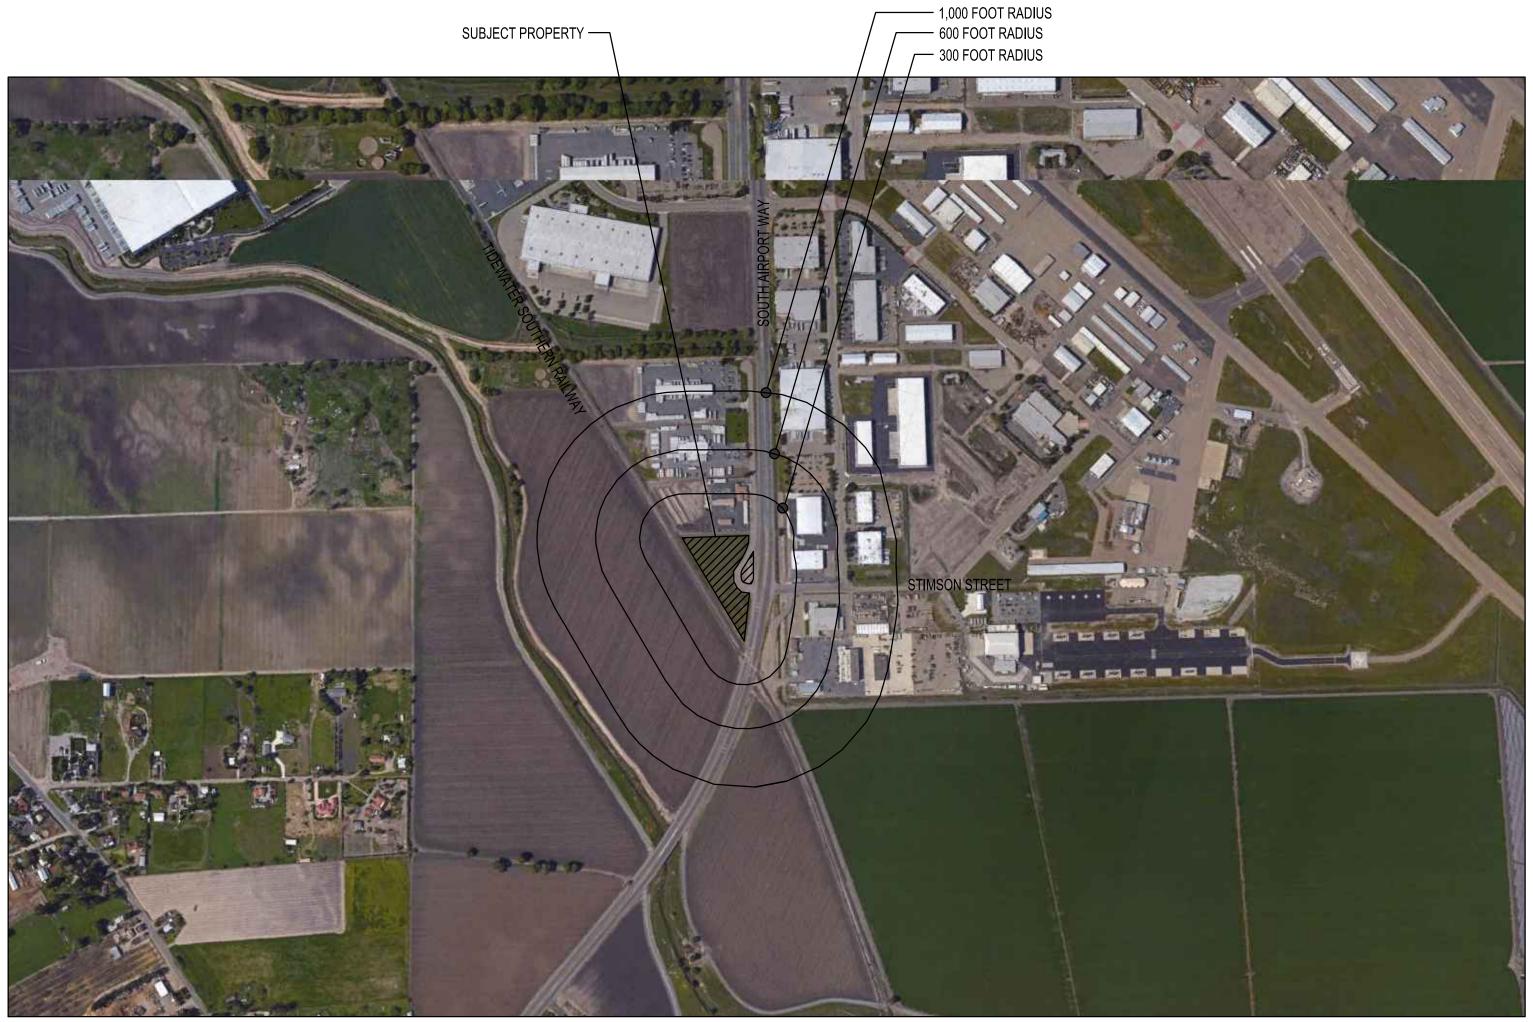

VICINITY MAP/ NIEGHBORHOOD CONTEXT SCALE: N.T.S.

NOTE: THERE IS NO RESIDENTIAL RESIDENTIAL ZONE WITHIN 300 FEET. THERE ARE NO CHILDCARE CENTERS, IN-HOME CHILD CARE, RELIGIOUS FACILITIES, DRUG ABUSE OR ALCOHOL TREATMENT FACILITIE FEET. THERE ARE NO PARKS, SCHOOLS OR OTHER MEDICA WITHIN 1,000 FEET. OUR STRATEGY FOR COMPLETING THIS NEIGHBORHOOD CONTEXT STUDY WAS TO DRIVE UP AND DOWN EVERY STREET WITHIN THE RADIUS BORDERS DEFINED ON THIS MAP AND VISUALLY OBSERVE ALL THE USES AND OCCUPANTS WITHIN THE CONTEXT AREA. THOSE FACILITIES OR SUITES THAT DID NOT HAVE OBVIOUS USES WERE APPROACHED FOR A CONVERSATION TO CONFIRM THE USE.

BSG ENGINEERING		
3366 Pierce St. Apt 203 Ph:415-521-0655 San Francisco, California 94123 burchgreene@gmail.com		
STOCKTON GREENHOUSE	BLOOM INNOVATIONS	7979 SOUTH AIRPORT WAY STOCKTON, CA 95206
STAMP:		79 S1
DATES ISSUED:	PTION	
REVISIONS: No. DATE	DESCRIPTION	
$\begin{array}{c c} \Delta \\ \hline \end{array}$		
DRAWING TITLE: PROPE SITE M	ERTY IN	IFO
SCALE:		
1/4" = 1'-0" DRAWN:	_	CHECKED:
SHEET No.:	4-1	BSG
PROJECT No.:	153	