FLORA STREET

BEDROOM

Unit 1

LIVING

One Bedroom/683 sf

LIVING

Unit 2 One Bedroom/635 sf

KITCHEN

DREIVEWAY

KITCHEN

GARAGE

SITE PLAN

FIRST FLOOR

BEDROOM

10'-0" SIDE STREET SETBACK

STREET

HUNTER

ż

F. Garcia

Stockton, California 95202

4-Unit

Apartments

748 N Hunter St Stockton, CA 95202

LEE . JAGOE

ARCHITECTURE



124 West Popular Street Stockton, CA 95202 (209) 688-0849 Sheet Index

CS Cover Sheet/SIte Plan

SP1.0 Site Plan Surrounding Photos L1 Preliminary Landscape Plan A1.1 Unit Plan/Roof Plan

A2.0 Exterior Elevations

A2.1 Exterior Elevations

A2.0 Colored Elevations

Scope of Work

Construction of 4 Unit Apartment Project Project is to be completed in one phase See sheet SP1_Site Plan for project data.

139-056-001 CO-Commercial Office Magnolia Historic District 5,000 sf 0.11 Acres 36.36 DU/AC

Building Coverage: Driveway Coverage: Landscape Coverage: 2,176 sf 472 sf 2,352 sf 43.52% 09.44% 47.04%

Building Area: Floor Area Ratio: 3,884 Sf 0.78 to 1.00

All buildings two stories Required Parking:

.5 Spaces/Unit

2 Spaces Provided 2 Spaces Provided Garage Parking: Open Parking: Open Space:

2 Spaces Provided
Usable Open Space 104 Sf
236 Sf 110 Sf/Unit

Cover Sheet/ Site Plan with Ground Floor Plan

Scale: 3/16" = 1'-0"

	SUBMITTAL	06/03/25	
Δ	PLAN CHECK #1		





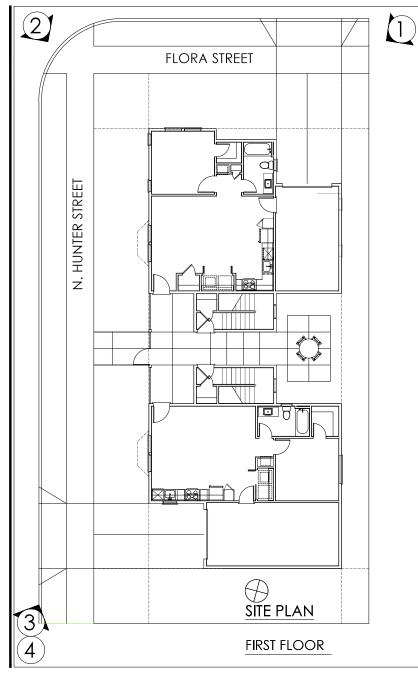








P25-0018 ATTACHMENT K









2 748 Hunter Street South StreetView



748 Hunter Street Northeast StreetView



(4) 748 Hunter Street Northeast Aerial View



F. Garcia

Stockton, California 95202

4-Unit Apartments
748 N Hunter St
Stockton, CA 95202

Site Photos

Scale: 3/16" = 1'-0"

	SUBMITTAL	06/03/25				
Δ	PLAN CHECK #1					



Sheet Number:

LI Of 3 Sheets

FLORA STREET 0 ** ОO ι_ΟΟί *© Ø $\circ \tilde{*}$ HUNTER STREET ○** '⊙¾

PLANTING NOTES

- ALL PLANING SHALL BE CONFICTED IN ACCESSION E WITH AND CONTRACTOR SHALL BE FAMILIAR WITH AND ASSESSMENT OF THE PROPERTY OF THE
- A BID. THE LANDSCAPE CONTRACTOR IS TO NOTIFY THE OWNERCOWNESS REPRESENTATIVEAS HOURS PRIOR TO A REQUIRED SHE ORDERVATION. THESE SHALL BY A SHE CRESPONDON OF PANT LICIATIONS. OF THE CONTRACTOR OF PANT LICIATIONS. OF THE CONTRACTOR OF THE CONTRACTO
- 4. FINISH GRADE IN PLANTERS SHALL BE US INCHES BELOW THE FOP OF ADJACENT PAVING. GRADE AUL PLANTING AREAS SMOOTH AND EVEN. ENSURE THAT ALL PLANTING AREAS MAINTAIN POSITIVE

- 4. PASHI GRADE IN PANIESS SHALL BE LIF. NOTHER BELOW THE 10T OF A DIACENT RAINE. GRADE ALL PLANTING AREAS SHOOTIN AND EXEN. REVEILS THAT ALL PANITING AREA MANISTAN POSITION FOR THE PANIES. AND PART ALL PANIES. AREA MANISTAN POSITION OF THE PANIES. AND PART ALL PANIES AREA MANISTAN POSITION. SO THE PANIES AND PART AND

PROPOS	SED PL	ANT LEGEND	TOTAL :ANDSCAPE AREA: 2,640.8 SQ.F	
Symbol TREES	Size	Botanical Name	Common Name Wa	ite: Use
	15 Gal.	Acer p. 'Bloodgood'	Red Japanese Maple	l
R	15 Gal.	Geyera parviflora	Australian Willow	L
\odot	15 Gal.	Pistachia chinensis	Chinese Pistache	L
	5 Gal. 5 Gal. 5 Gal. 5 Gal. 5 Gal. 5 Gal.	Bacchans p. Figeon Point' Ceanothus g.h. Yarkee Point' Loropetalum chinemis Pittosporm Wheelers Dwarf Phornium t. 'rubra' Podocarpus m. 'Malo'	Dwarf Coyote Brush Yankee Point California Ulao Chinese Finage Flower Dwarf Pitrosporum Red New Zealand Flax Shrubby Yew Pine	L L L L
GROUNDCO	VERS AND AC	CENTS		
∞	I Gal.	Dietes vegeta	Fortniaht Lily	L

MWELO CALCULATIONS

| FRONTICOMMON LANDSCAPE AREA: 2,640.8 SQ FT |
9FECIAL LANDSCAPE AREA: 0 SQ FT |
FREFERENCE ETG: 53.4 |
IRRIGATION METHOD/EFFICIENCY: SUB-SURFACE DRIP().8

HYDROZONE PLANT FACTOR IRRIGATION EFFICIENCY ETAF HYDROZONE AREA (HA)
- 0.4 0.81 0.32 2.640.8

= (ETo)(O.G2)(ETAF)(HA)

= (49.1) (0.62)(0.32)(2.640.8))

= 25,725,2 GALLONS PER YEAR MAWA:36,177.3 > ETWU: 25,725.2

LANDSCAPE SUMMARY

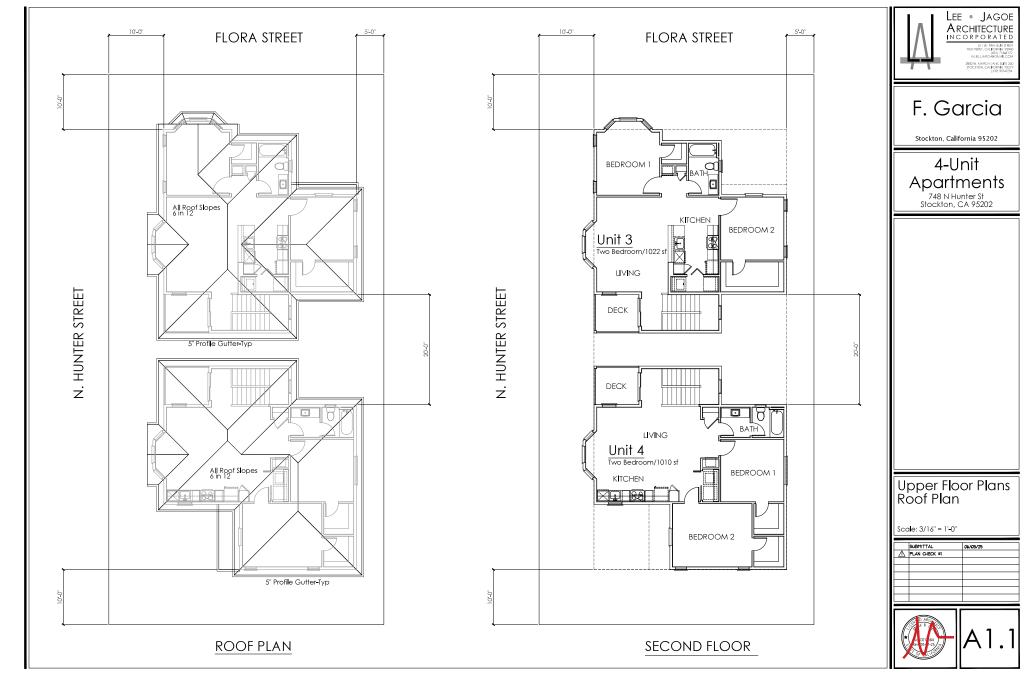
* I HAVE COMPLIED WITH THE CRITERIA OF THE MODEL WATER EFFICIENT LANDSCAPE ORDINANCE AND APPLIED THEM FOR THE EFFICIENT USE OF WATER IN THE LANDSCAPE AND IRRIGATION DESIGN PLANS

(A)

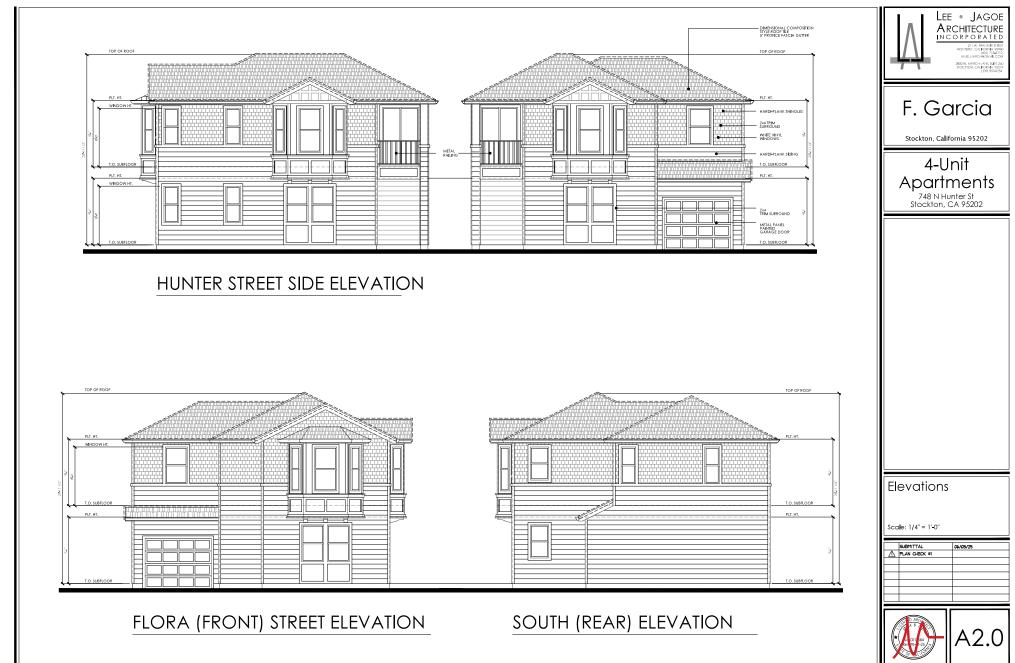
I Gal. Dietes vegeta Fortnight bly
I Gal. Unope m Silvery Sunproof Vanegated bly Turf Seed Myoporum p. 'Prostratum' - White Creeping Myoporum

MAWA = (EFo) (0.62) (0.45 X LA)+(1-0.45 X SLA) = (49.1)(0.62)(0.45 X 2,640.8) = (49.1)(0.62)(1,188.4) = 36,177.3 GALLONS PER YEAR

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